

City of Fitchburg Planning/Zoning Department 5520 Lacy Road Fitchburg, WI 53711 (608-270-4200)

### **ARCHITECTURAL & DESIGN REVIEW APPLICATION**

\*See originally approved plans (2012) for additional info

Applicant/Contact Person: <u>Hy-Vee, Inc. (John Brehm)</u>	
Address: 5820 Westown Parkway	Phone Number of Contact Person: 515-720-3556
City, State, Zip Code: West Des Moines, IA 50266	Email of Contact Person: JBrehm@hy-vee.com
Project Address: 2920 Fitchrona Rd.	Lot:Subdivision:
Project Type: Multi-Family <u>X</u> Commercial	Industrial Other
New Addition	
Impervious Surface Ratio (ISR): See Plans (City Standard	d: maximum 65% ISR)
All items listed below must be included with the application to application, the applicant must provide in writing the basis for Fitchburg Plan Commission for architectural and design revie	not including it. Building and site plans submitted to the
feet of the site  8. ISR shall be indicated on  9. Stormwater management	s, drive, etc. (rivers, ponds, wetlands). improvements.
4. Location of well, septic ta	lings, improvements and natural features. unk, drainfield, etc. (if applicable) tions or new structures, including trash/recycling enclosure(s). frame, structural steel, etc.). ement, slab on grade, etc.).  ype, color, texture, etc. ned, flat, etc.) and pitch. solor, texture, etc. w location, size, type, etc.
Ingress, Egress, Parking:  1. Location of highway and 2. Location, size, configurat 3. Number, size, location of 4. Location of handicapped 5. Bicycle rack(s).	ion of drivers and walks.

### ARCHITECTURAL AND DESIGN REVIEW APPLICATION Page 2

Landscaping:

<ol> <li>Location, species, size of existing trees, shrubs, and plantings. *See originally approfor additional info</li> <li>Location, species, size of proposed plantings.</li> <li>Location and size of all paved, seeded/sodded and gravelled areas.</li> <li>Location of all retaining walls, fences, berms and other landscape features.</li> </ol>	ved plans (201
*It is highly recommended that an applicant hold at least one neighborhood meeting prior to submitting an ADR application to identify any concerns or issues of surrounding residents.	
The preceding information is considered to be the minimum information for submission, and the City may require additional information for its review. Any interpretations provided by city officials as the result of submitting the attached information are based on the submitted plans, and any plan changes, may affect the interpretations.	
It is the responsibility of the owner/applicant to insure compliance with all local and state requirements. The below signed applicant acknowledges the above information and hereby submits the attached information for the City's Architectural and Design Review Process.	
Signed: See Letter of Intent for Applicant Signature Date: June 23, 2020  Applicant or Authorized Agent	
*** Application shall be accompanied by one (1) sets of full-size plans, two (2) sets no larger than 11"x17", ar one (1) pdf document of the complete submittal to planning@fitchburgwi.gov. Applications are due at least 4	d
weeks prior to the desired Plan Commission Meeting. The time frame assumes a complete set of plans is provided, and if it is not provided the Plan Commission date will be adjusted.	
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City, State, Zip Code	e: West Des	Moines, IA 50	)266	Email of Contact Persor	n: JBrehm@hy-vee.com
Project Address: 29	20 Fitchrona	Rd.		Lot: Subd	ivision:
Project Type:	Multi-Fami	ly X	Commercial	Industrial	Other
	New	Additio	n		
Impervious Surface	Ratio (ISR)	: See Plans	(City Standard	: maximum 65% ISR)	
application, the applic	ant must pr	ovide in writing	g the basis for		f an item is not included with the nd site plans submitted to the g information:
Site Data:		<ol> <li>Orientation</li> <li>Adjacent high</li> <li>Existing nation</li> <li>Existing builing</li> <li>Existing and</li> <li>Utility plans feet of the</li> <li>ISR shall be</li> <li>Stormwater</li> </ol>	ghways, roads tural features ( ildings and/or in d proposed site s, including main site e indicated on a management	, drive, etc. rivers, ponds, wetlands). mprovements. e drainage. in/lateral sizes and existing	g grading plan.
<u>Building:</u>		2. Distance from the property of the property	om lot lines. om other buildi well, septic tar proposed additi on type (wood fi type (full base levels. rior covering ty (gable, hip, sh naterial type, co	n and orientation.  ngs, improvements and nank, drainfield, etc. (if applications or new structures, incomment, structural steel, etc.)  grame, structural steel, etc.  grament, slab on grade, etc.)  grape, color, texture, etc.  ed, flat, etc.) and pitch.  color, texture, etc.  w location, size, type, etc.  s or fire alarm systems.	able) luding trash/recycling enclosure(s). ).
Ingress. Egr	ess. Parkin	a:			

- Location of highway and road access points.
   Location, size, configuration of drivers and walks. \*See originally approved plans (2012) for additional info

- Number, size, location of parking spaces.
   Location of handicapped parking and accessible building entrances.
- 5. Bicycle rack(s).

### ARCHITECTURAL AND DESIGN REVIEW APPLICATION Page 2

Signed: See Letter of Intent for Applicant Signature

Landscaping:			:	
	Lanc	ısca	pıng	7:

X	
X	

1. Location, species, size of existing trees, shrubs, and plantings. \*See originally approved plans (2012)

for additional info

Date: June 23, 2020

2. Location, species, size of proposed plantings.

3. Location and size of all paved, seeded/sodded and gravelled areas.

4. Location of all retaining walls, fences, berms and other landscape features.

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FOR CITY USE ONLY					
Date Received:	Plan Commission Date:				
Comments:					



Lisa McNabola Associate Planner City of Fitchburg 5520 Lacy Road Fitchburg, WI 53711

### RE: HY-VEE AISLES ONLINE PICK UP POINT LETTER OF INTENT

Dear Ms. McNabola:

We are pleased to submit the attached site plans and building elevations for our proposed Aisles Online Pick Up point at the Fitchburg Hy-Vee. We have been working on how to better serve our customers with online grocery ordering, delivery, and pickup over the past several years. We were working with order volumes that could be easily accommodated with several dedicated parking stalls prior to the COVID-19 disruption. In a matter of a week, we went from processing 50 to 60 online orders each day to processing hundreds of orders per hour each day. To provide room to stage the orders and get traffic away from the front of our stores, we set a portable office in our parking lot to hold customer orders for pickup.

We anticipate a steady increase in online orders in the coming years. We are requesting approval to install a permanent installation for pick up service in our parking lot. Attached please find the proposed elevations of the facility and canopy that will anchor this location. The pick up point has been located away from the store to avoid traffic conflicts along the front of the store and in the parking lot. The storage area is to hold orders right before pick up. The canopy acts as both a wayfinding device for customers and shelter from the elements for our employees as they load vehicles with groceries.

To date, we've learned that online orders are an offset to the number of trips to the store. We may see the same total number of trips to the store, but roughly ten percent of those trips are online orders. The online orders do not need a parking space in the lot, thus reducing our needed parking count. Orders are processed in incremental time slots to control the number of trips coming to the store. We are seeing our peak hours between 4 pm and 6 pm as customers pick up their groceries on the way home from work. Typical hours of operation are from 8 am to 10 pm, but may be less based on demand at a location.

We look forward to working with the City to make this a successful program. If you have any questions or need additional information, please feel free to write or call.

Sincere

John Brehm

Director, Site Planning

Enclosures

Cc: Phil Hoey, Hy-Vee, Inc.

Justin Frahm, JSD

File

Hy-Vee, Inc.

5820 Westown Parkway, West Des Moines, Iowa 50266

Phone: (515) 267-2800



# SITE CONSTRUCTION DOCUMENT PACKAGE

# HY-VEE FITCHBURG #1 2920 FITCHRONA ROAD FITCHBURG, WI 53719 ONLINE AISLES KIOSK

# OWNER/DEVELOPER

HY-VEE, INC. 5820 WESTOWN PARKWAY WEST DES MOINES, IOWA 515-267-2800

# **CIVIL ENGINEER**

JSD PROFESSIONAL SERVICES, INC. 161 HORIZON DRIVE, SUITE 101 VERONA, WI 53593 608-848-5060

# LANDSCAPE ARCHITECT

JSD PROFESSIONAL SERVICES, INC. 161 HORIZON DRIVE, SUITE 101 VERONA, WI 53593 608-848-5060

# **REGULATORY AGENCIES**

CITY ADMINISTRATOR PATRICK MARSH 608-270-4209

CITY ENGINEER/PUBLIC WORKS BILL BALKE 608-270-4264

FIRE CHIEF JOE PULVERMACHER 608-278-2980

POLICE CHIEF CHAD BRECKLIN 608-270-4300

# SHEET INDEX

C0.0 COVER SHEET

C1.0 EXISTING CONDITIONS & OVERALL SITE MAP

C1.1 DEMOLITION PLAN

C2.0 SITE/LANDSCAPE PLAN

C3.0 GRADING PLAN

C3.1 EROSION CONTROL PLAN

C4.0 UTILITY PLAN


C5.0 CONSTRUCTION DETAILS

# PLANS ISSUED

REV	DATE	DESCRIPTION
	06/23/2020	ARCHITECTURAL & DESIGN REVIEW APPLICATION

# **SITE LOCATION MAP**

OT TO SCALE

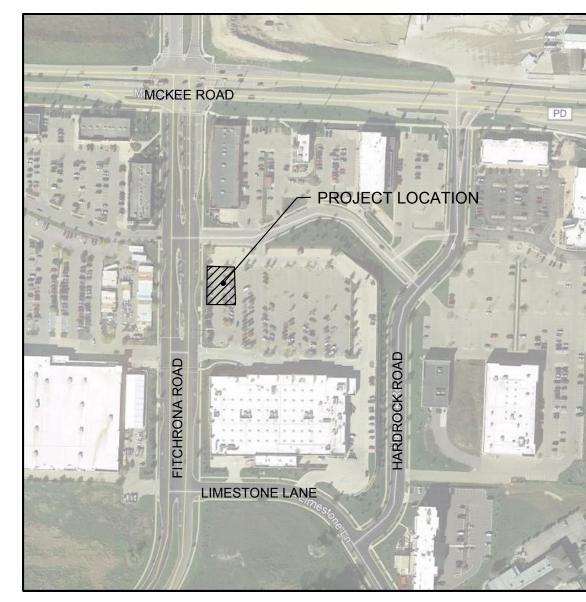

# UTILITY CONTACTS


DIGGER'S HOTLINE 800-242-8511


GAS MADISON GAS & ELECTRIC 608-252-5618

ELECTRIC ALLIANT ENERGY 608-845-1148

TELEPHONE/CABLE AT&T 608-252-2432



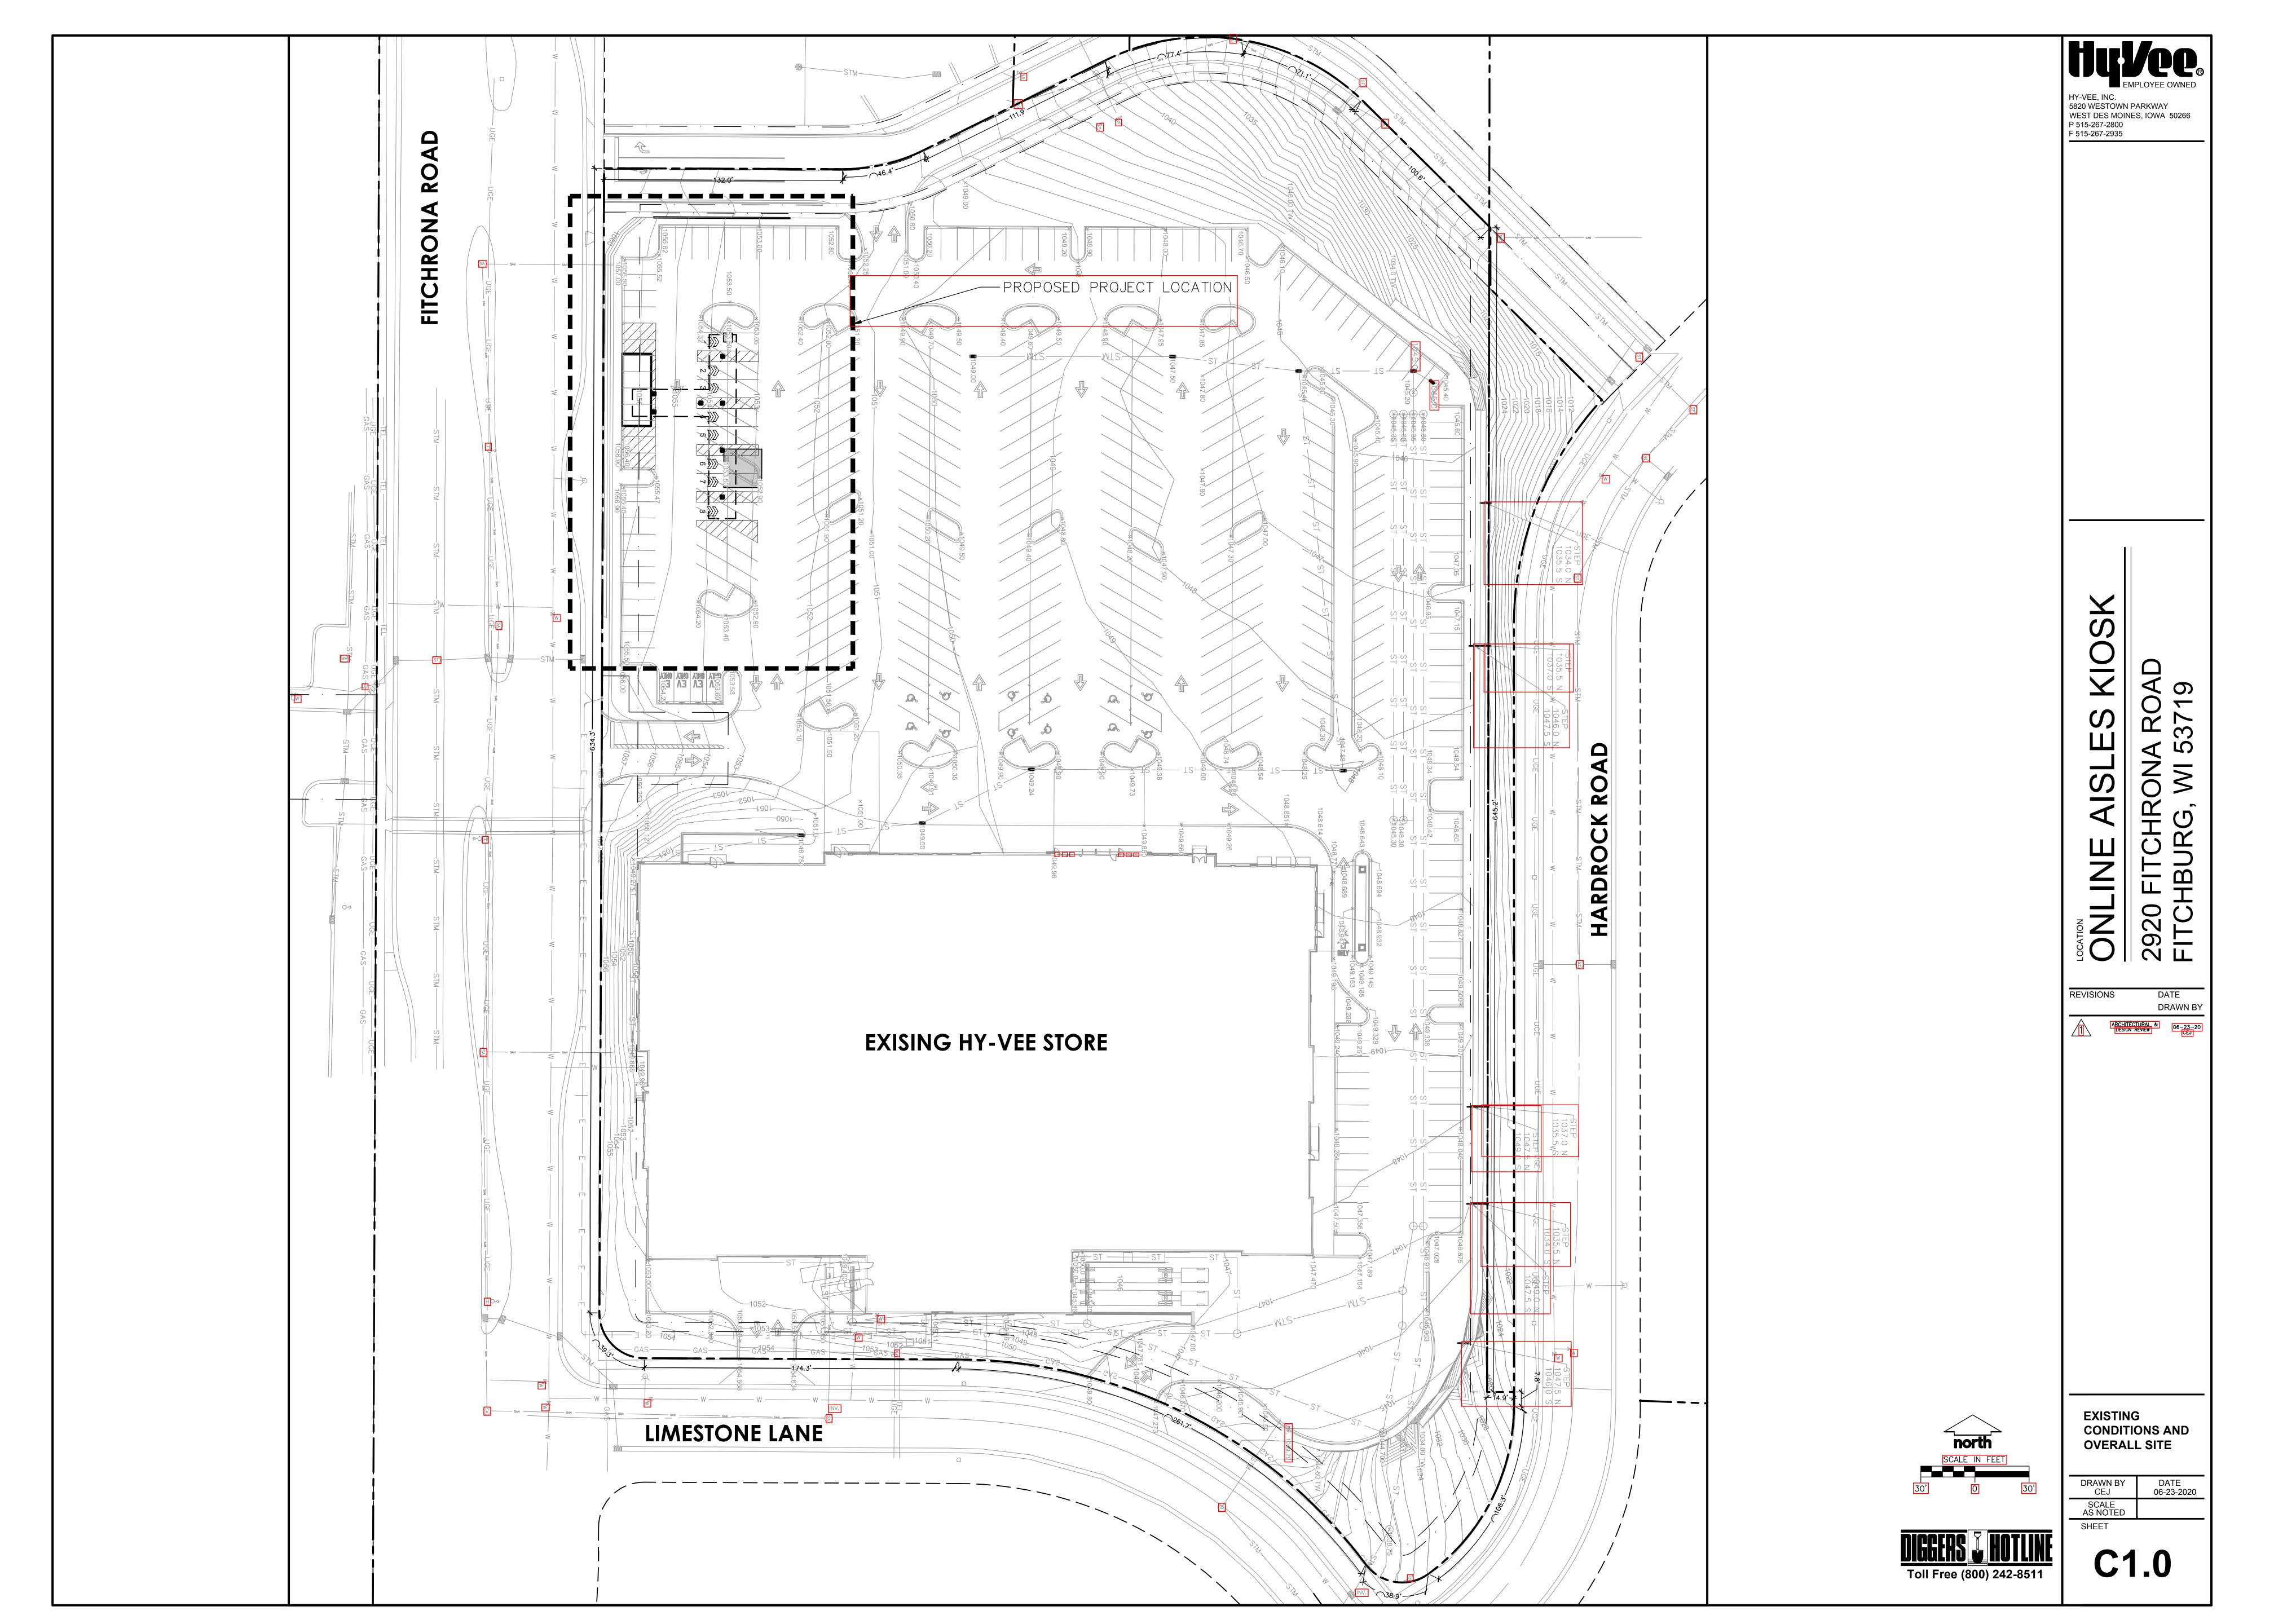

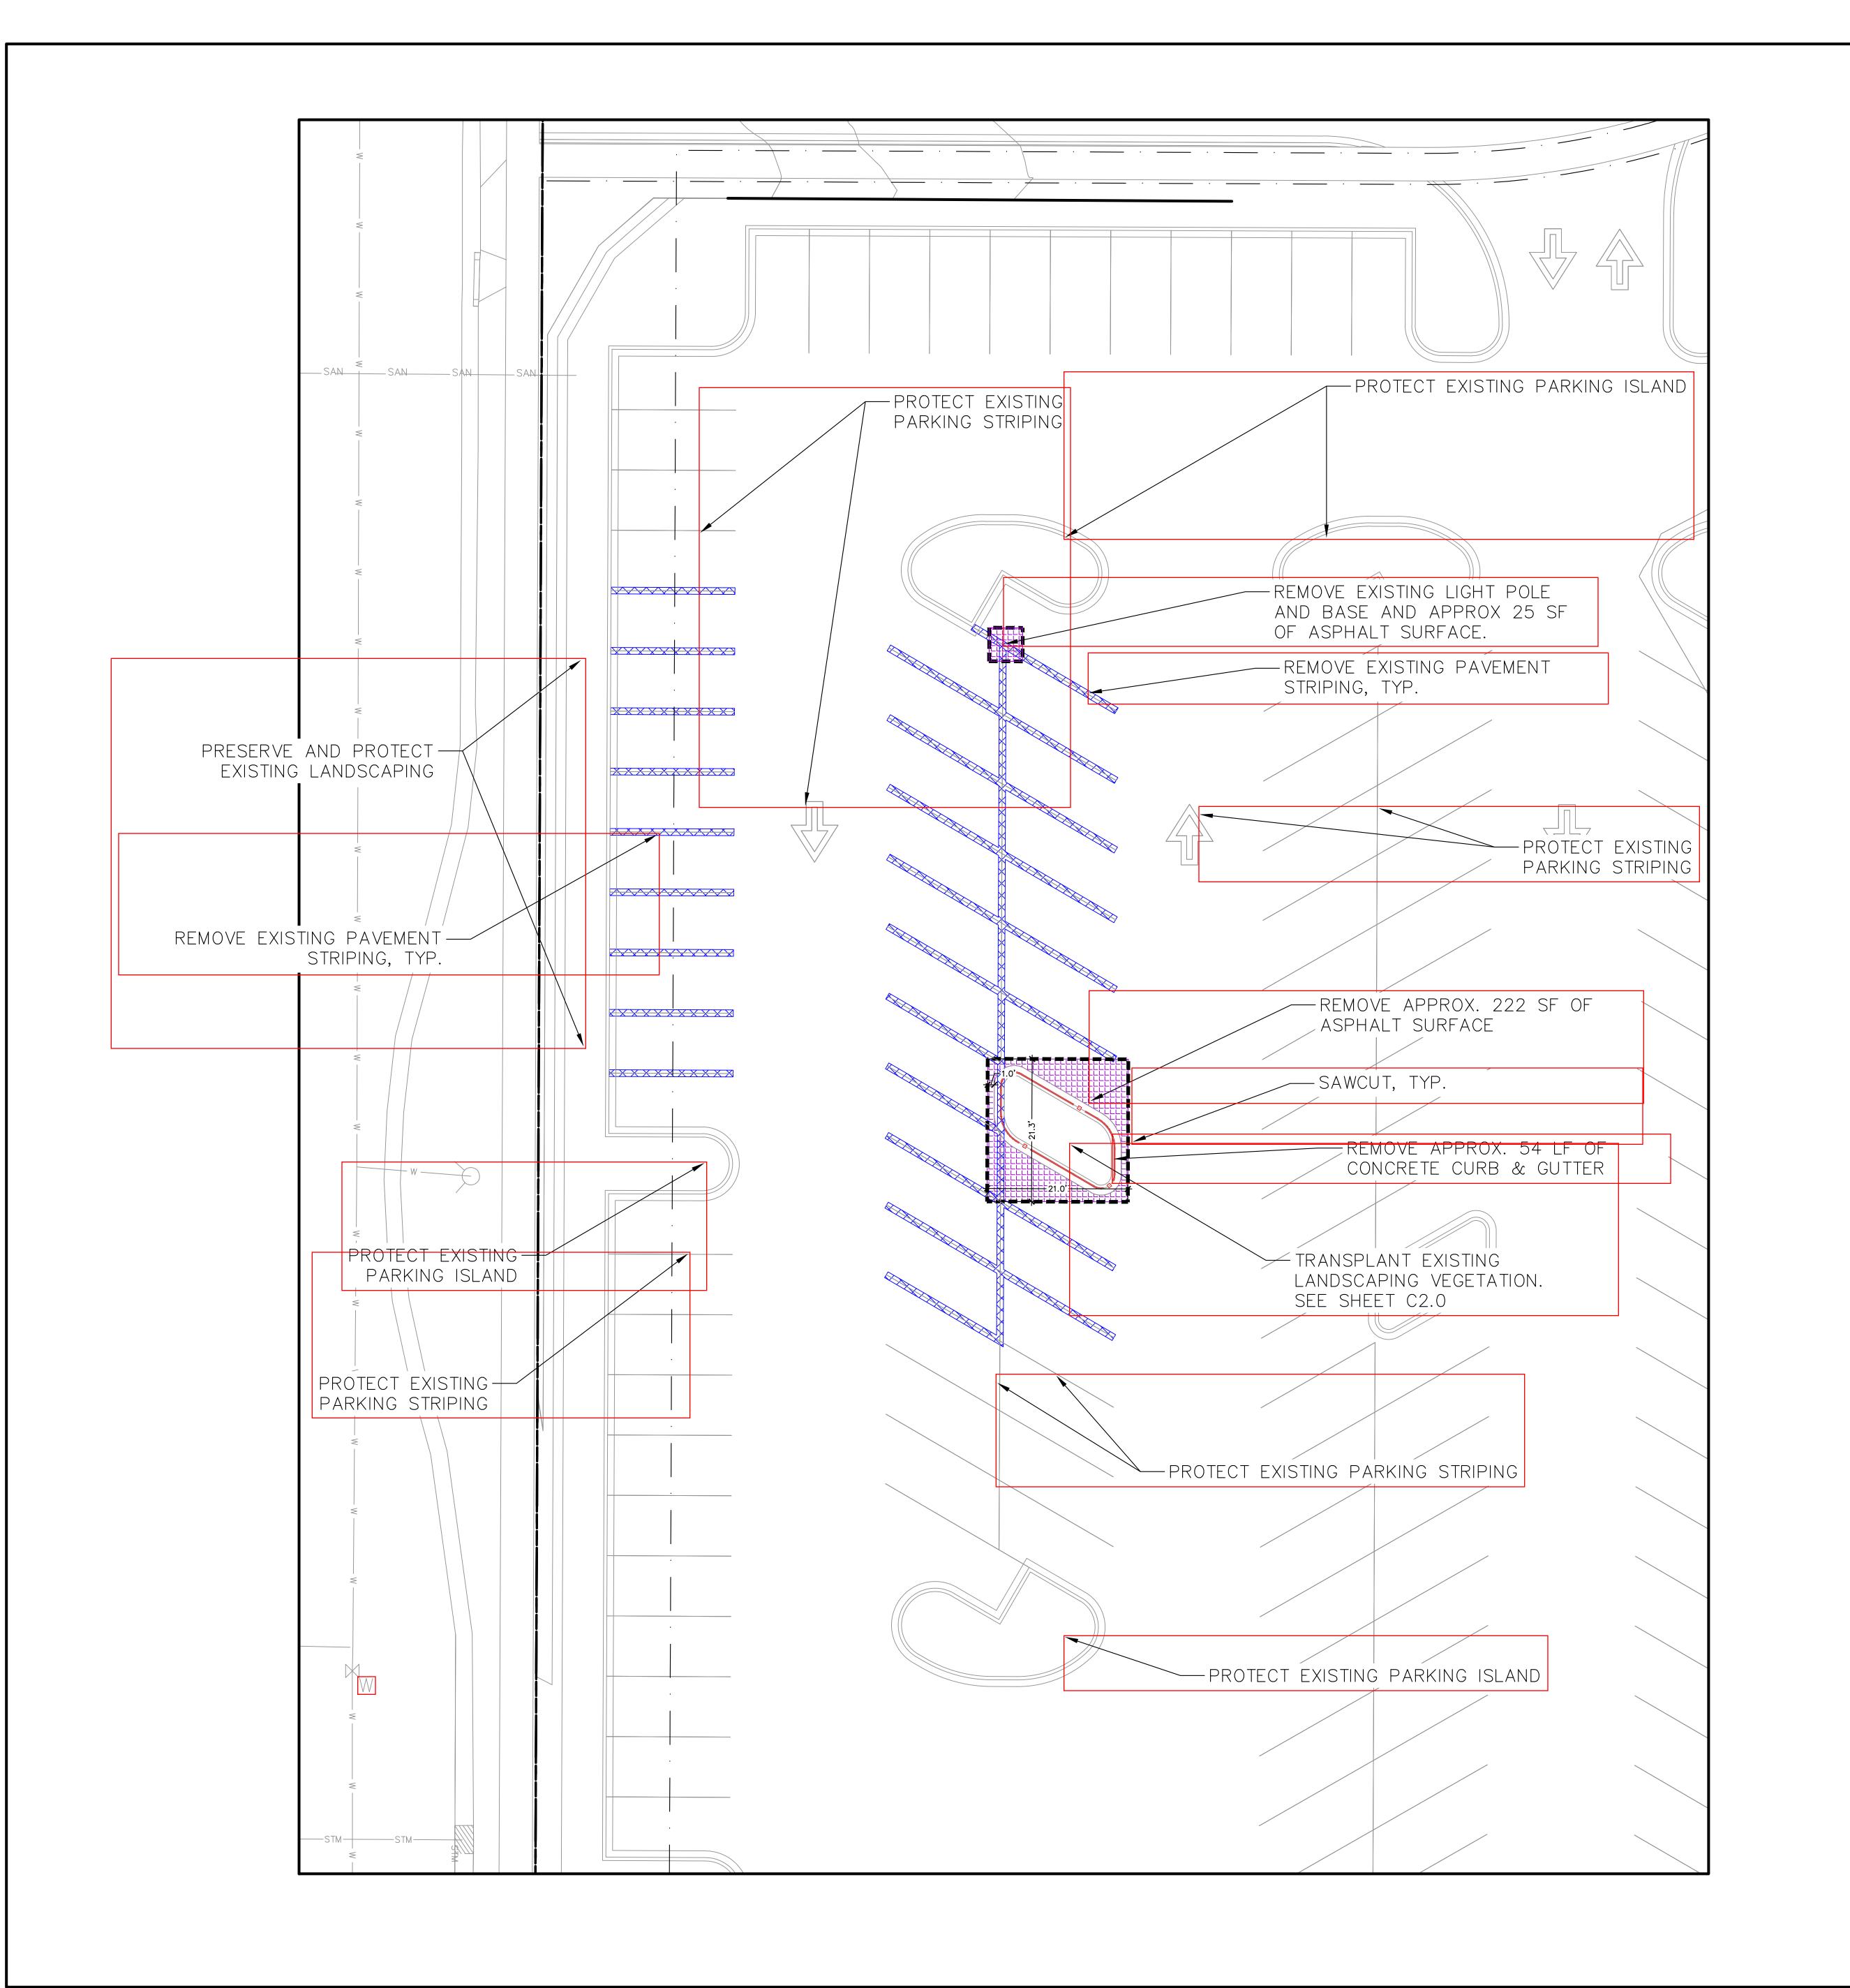

### **DEMOLITION NOTES**

1. REMOVAL OR ABANDONMENT OF PUBLIC UTILITIES SHALL BE FULLY COORDINATED WITH APPROPRIATE UTILITY SUPPLIER AND REGULATORY AGENCIES.

2. ALL CONSTRUCTION/DEMOLITION DEBRIS SHALL BE DISPOSED OF OR RECYCLED OFF SITE IN FULL COMPLIANCE WITH CURRENT ENVIRONMENTAL REGULATIONS.

3. PROTECT ADJACENT PROPERTY DURING DEMOLITION.

4. PROTECT EXISTING UTILITIES WHICH ARE TO REMAIN. THE LOCATIONS OF ALL UTILITIES INDICATED ON THE PLANS ARE TAKEN FROM EXISTING RECORDS. THE EXACT LOCATION AND ELEVATION OF ALL UTILITIES MUST BE DETERMINED BY THE CONTRACTOR. IT SHALL BE THE DUTY OF THE CONTRACTOR TO ASCERTAIN WHETHER ANY ADDITIONAL FACILITIES OTHER THAN THOSE SHOWN MAY BE PRESENT.

5. REMOVE ALL DESIGNATED STREETS, DRIVEWAYS, ETC. IN THEIR ENTIRETY. BACKFILL ALL EXCAVATIONS WITH COHESIVE MATERIAL COMPACTED TO 98% STANDARD PROCTOR DENSITY. BACKFILLING TO BE OBSERVED BY GEOTECHNICAL ENGINEER EMPLOYED BY OWNER.

6. DEMOLITION NOTES AS SHOWN ON THE PLAN ARE NOT ALL INCLUSIVE. CONTRACTOR TO ABANDON IN PLACE OR REMOVE AND DISPOSE OF ALL EXISTING SITE IMPROVEMENTS ABOVE AND BELOW GROUND TO COMPLY WITH THE GENERAL INTENT OF THIS DOCUMENT.

7. CONTRACTOR SHALL BE RESPONSIBLE FOR LOCATING ALL UTILITIES PRIOR TO CONSTRUCTION, BOTH PUBLIC AND PRIVATE

8. CONTRACTOR SHALL BE RESPONSIBLE FOR REMOVING AND SALVAGING ANY IRRIGATION COMPONENTS AND ADJUSTING IRRIGATION AS REQUIRED FOR OPERATION ON REMAINDER OF SITE DURING CONSTRUCTION.

9. CONTRACTOR SHALL BE RESPONSIBLE FOR COORDINATING SITE DEMOLITION PRIOR TO CONSTRUCTION.

HY-VEE, INC.
5820 WESTOWN PARKWAY
WEST DES MOINES, IOWA 50266
P 515-267-2800

F 515-267-2935

ONLINE AISLES KIOS 2920 FITCHRONA ROAD FITCHBURG, WI 53719

DRAWN BY

REVISIONS

LEGEND

DEMOLITION — REMOVAL OF ONSITE CURB SURFACES AND BASE COURSE

DEMOLITION — REMOVAL OF ASPHALT SURFACES

DEMOLITION — REMOVAL OF PAVEMENT STRIPING

SAWCUT EXISTING PAVEMENT

north

SCALE IN FEET


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**DIGGERS HOTLINE**Toll Free (800) 242-8511

**DEMOLITION PLAN** 

DRAWN BY DATE 06-23-2020
SCALE AS NOTED

C1.1

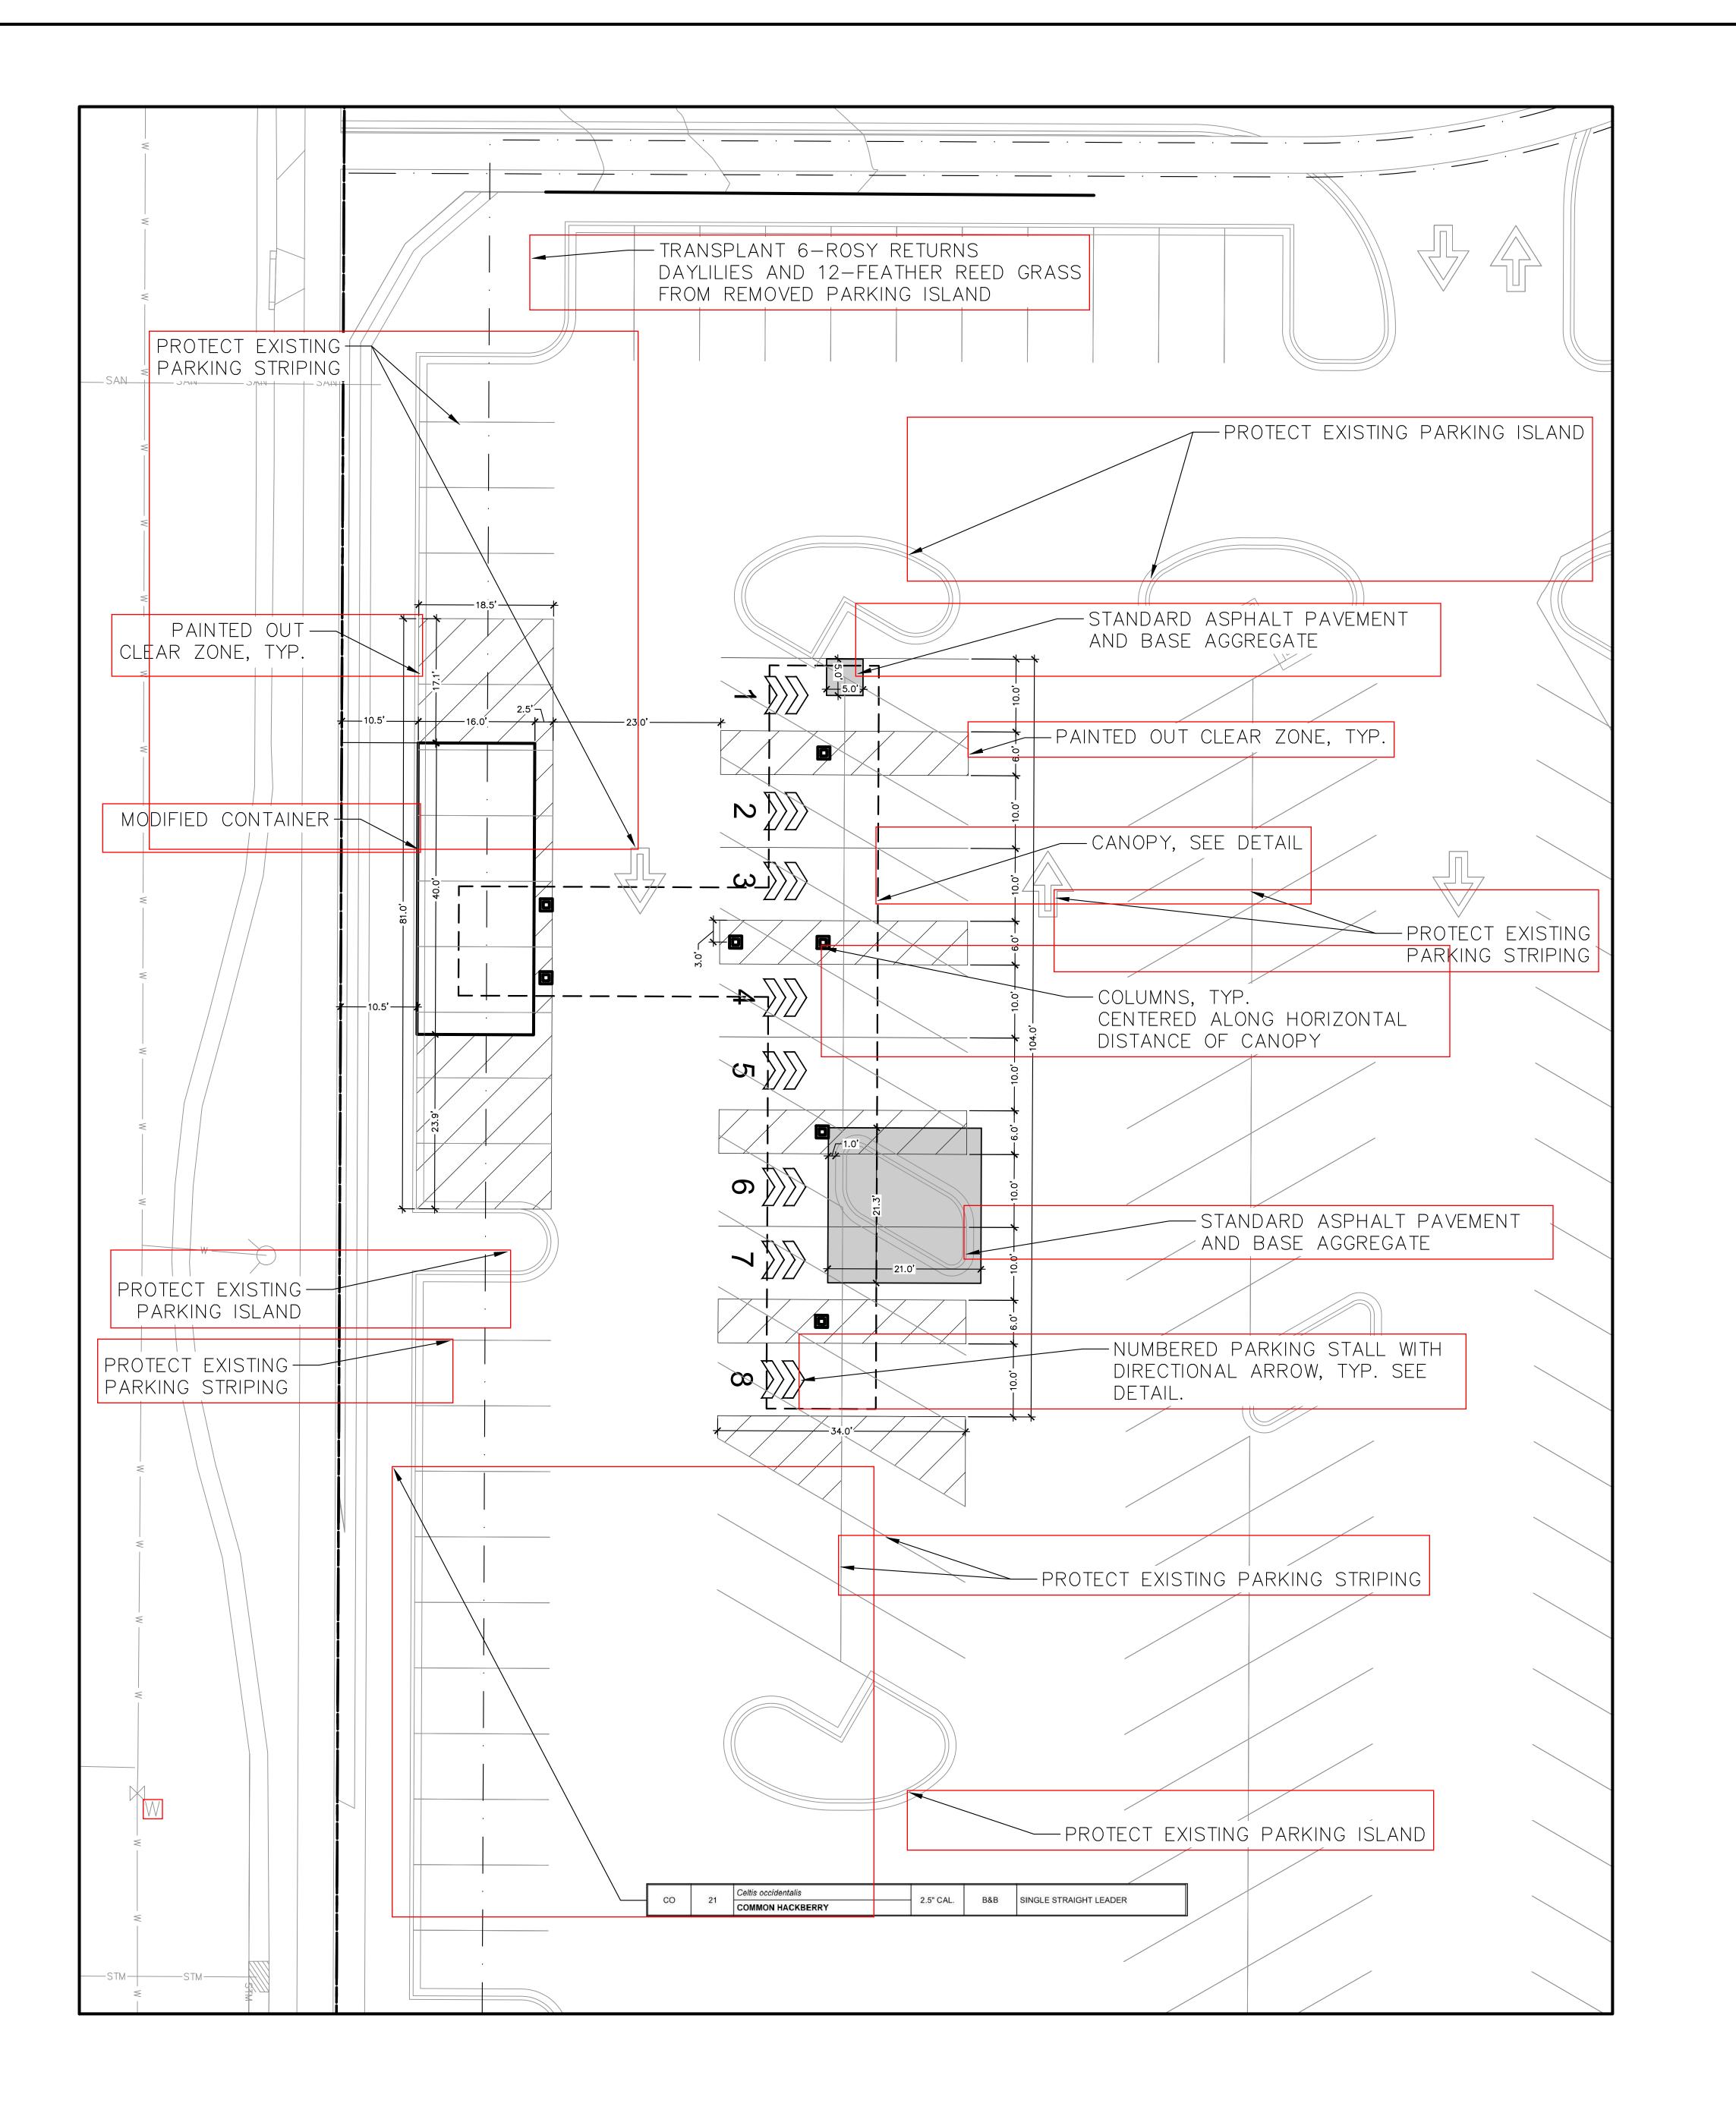

### **GENERAL NOTES**

1. PROTECT EXISTING STRUCTURES AND ADJACENT PROPERTY DURING CONSTRUCTION.

2. PROTECT EXISTING UTILITIES DURING CONSTRUCTION.

3. THE LOCATIONS OF ALL UTILITIES INDICATED ON THE PLANS ARE TAKEN FROM EXISTING RECORDS. THE EXACT LOCATION AND ELEVATION OF ALL UTILITIES MUST BE DETERMINED BY THE CONTRACTOR. IT SHALL BE THE DUTY OF THE CONTRACTOR TO ASCERTAIN WHETHER ANY ADDITIONAL UTILITIES OTHER THAN THOSE SHOWN ON THE PLAN MAY BE PRESENT.

4. ALL DIMENSIONS TO BACK-OF-CURB UNLESS NOTED OTHERWISE. ALL DIMENSIONS TO BE FIELD VERIFIED.

5. ALL SLOPES IN PAVEMENT SHALL BE UNIFORM TO AVOID PONDING.

6. FINISH GRADES SHOWN ARE TO TOP OF PAVING, SIDEWALKS, OR FINISH GRADE.

7. STAGING LOCATION FOR CONSTRUCTION EQUIPMENT AND MATERIALS TO BE COORDINATED WITH AND APPROVED BY THE OWNER.

### **PAVEMENT SPECIFICATIONS**

### ASPHALT:

1. TACK COAT. REFER TO IOWA SUDAS SPECIFICATIONS: A. PG 66-22

2. APPLY TACK COAT AT .08 GSY RESIDUAL RATE ON CLEAN, DRY SURFACE FREE OF LOOSE PARTICLES PRIOR TO PLACING HMA MIX.

3. HOT MIX ASPHALT. REFER TO IOWA SUDAS SPECIFICATIONS: A. SUBMIT MIX DESIGN FOR APPROVAL B. HMA STANDARDS TRAFFIC (ST) SURFACE: ½", PG 58-28H C. MAXIMUM RAP: 20%

4. PLACE THE HMA MIXTURE IN THE NUMBER OF LIFTS REQUIRED TO PRODUCE THE REQUIRED THICKNESS. THE COMPACTED THICKNESS OF THE TOP LIFT SHALL NOT EXCEED 2 INCHES.

5. PLACE SUCCEEDING LIFTS OF HMA AS SOON AS THE PREVIOUS LIFT HAS BEEN

6. COMPACT EACH LIFT TO 92-96% DENSITY. VERIFY DENSITY BY PROVIDING CORES PER OWNERS TESTING AGENCY.

### SIGNAGE AND STRIPING SPECIFICATIONS:

1. PAINT TRAFFIC DIRECTION ARROWS AND PARKING STRIPES "TRAFFIC YELLOW". 2. PAINT SHALL BE LEAD FREE WATERBORNE TRAFFIC AND HIGHWAY MARKING PAINT UC-3586 YELLOW AS MANUFACTURED BY DIAMOND VOGEL PAINTS OR EQUIVALENT.

3. PROVIDE FOUNDRY GRADE SILICA SAND THAT MEETS A 50/60 GRADED SAND WHEN TESTED ACCORDING TO ASTM C-136 OR GLASS BEADS THAT MEET FEDERAL SPECIFICATION TT-B-1325, TYPE I, GRADATION A.

4. BEFORE APPLICATION OF PAINT, PAINTING SURFACE MUST BE DRY AND FREE FROM DIRT, GREASE, OIL, OR OTHER MATERIAL THAT WOULD REDUCE THE BOND BETWEEN THE PAVEMENT AND PAINT. CLEAN THE AREA TO BE PAINTED BY SWEEPING OR COMPRESSED AIR.

5. APPLY PAINT AT LOCATIONS, DIMENSIONS, AND SPACING SHOWN ON THE PLANS.

6. MIX PAINT IN ACCORDANCE WITH MANUFACTURER'S INSTRUCTIONS AND APPLY AT THE RATE OF 115 SF/GALLON. THE ADDITION OF THINNER WILL NOT BE PERMITTED.

7. APPLY SILICA SAND AT 4LBS/GALLON OF PAINT IMMEDIATELY AFTER THE APPLICATION OF PAINT. SILICA SAND SHALL ADHERE TO THE CURED PAINT PRIOR TO FINAL ACCEPTANCE AND PAYMENT.

8. TREAT GLASS BEADS WITH ADHESION PROMOTING COATINGS AS SPECIFIED BY THE PAINT MANUFACTURER. APPLY GLASS BEADS AT 7LBS/GALLON OF PAINT IMMEDIATELY AFTER THE APPLICATION OF PAINT. GLASS BEADS SHALL ADHERE TO THE CURED PAINT PRIOR TO FINAL ACCEPTANCE OF PAYMENT.


9. PROTECT ALL MARKINGS FROM DAMAGE UNTIL PAINT IS DRY.

# **PARKING COUNTS:**

SITE REQUIREMENT: 342 STALLS (PLAN COMMISSION - FEB 2012)

CURRENT SITE: 411 STALLS -14 STALLS FOR CART CORRALS -31 STALLS FOR GROCERY PICKUP KIOSK +8 STALLS UNDER GROCERY PICKUP CANOPY

PROPOSED SITE: 374 STALLS

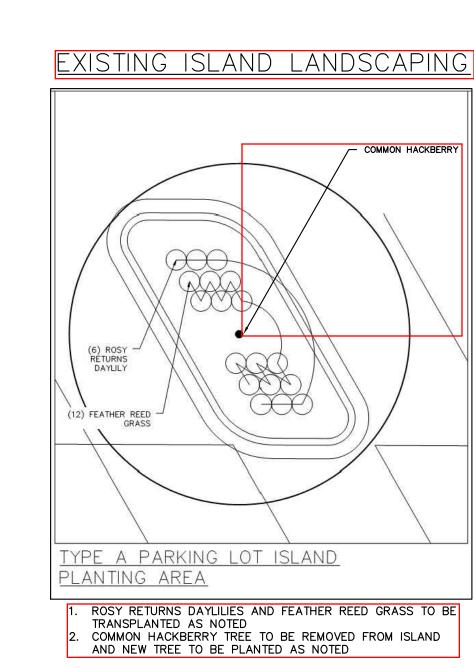

**LEGEND** PROPERTY LINE -----EASEMENT LINE BUILDING OVERHANG

PAVEMENT SETBACK LINE EDGE OF PAVEMENT STANDARD CURB AND GUTTER REJECT CURB AND GUTTER

MOUNTABLE CURB AND GUTTER

ASPHALT PAVEMENT

HY-VEE, INC. 5820 WESTOWN PARKWAY WEST DES MOINES, IOWA 50266 P 515-267-2800 F 515-267-2935


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DATE DRAWN BY

REVISIONS

SITE/LANDSCAPE **PLAN** 

06-23-2020 SCALE AS NOTED

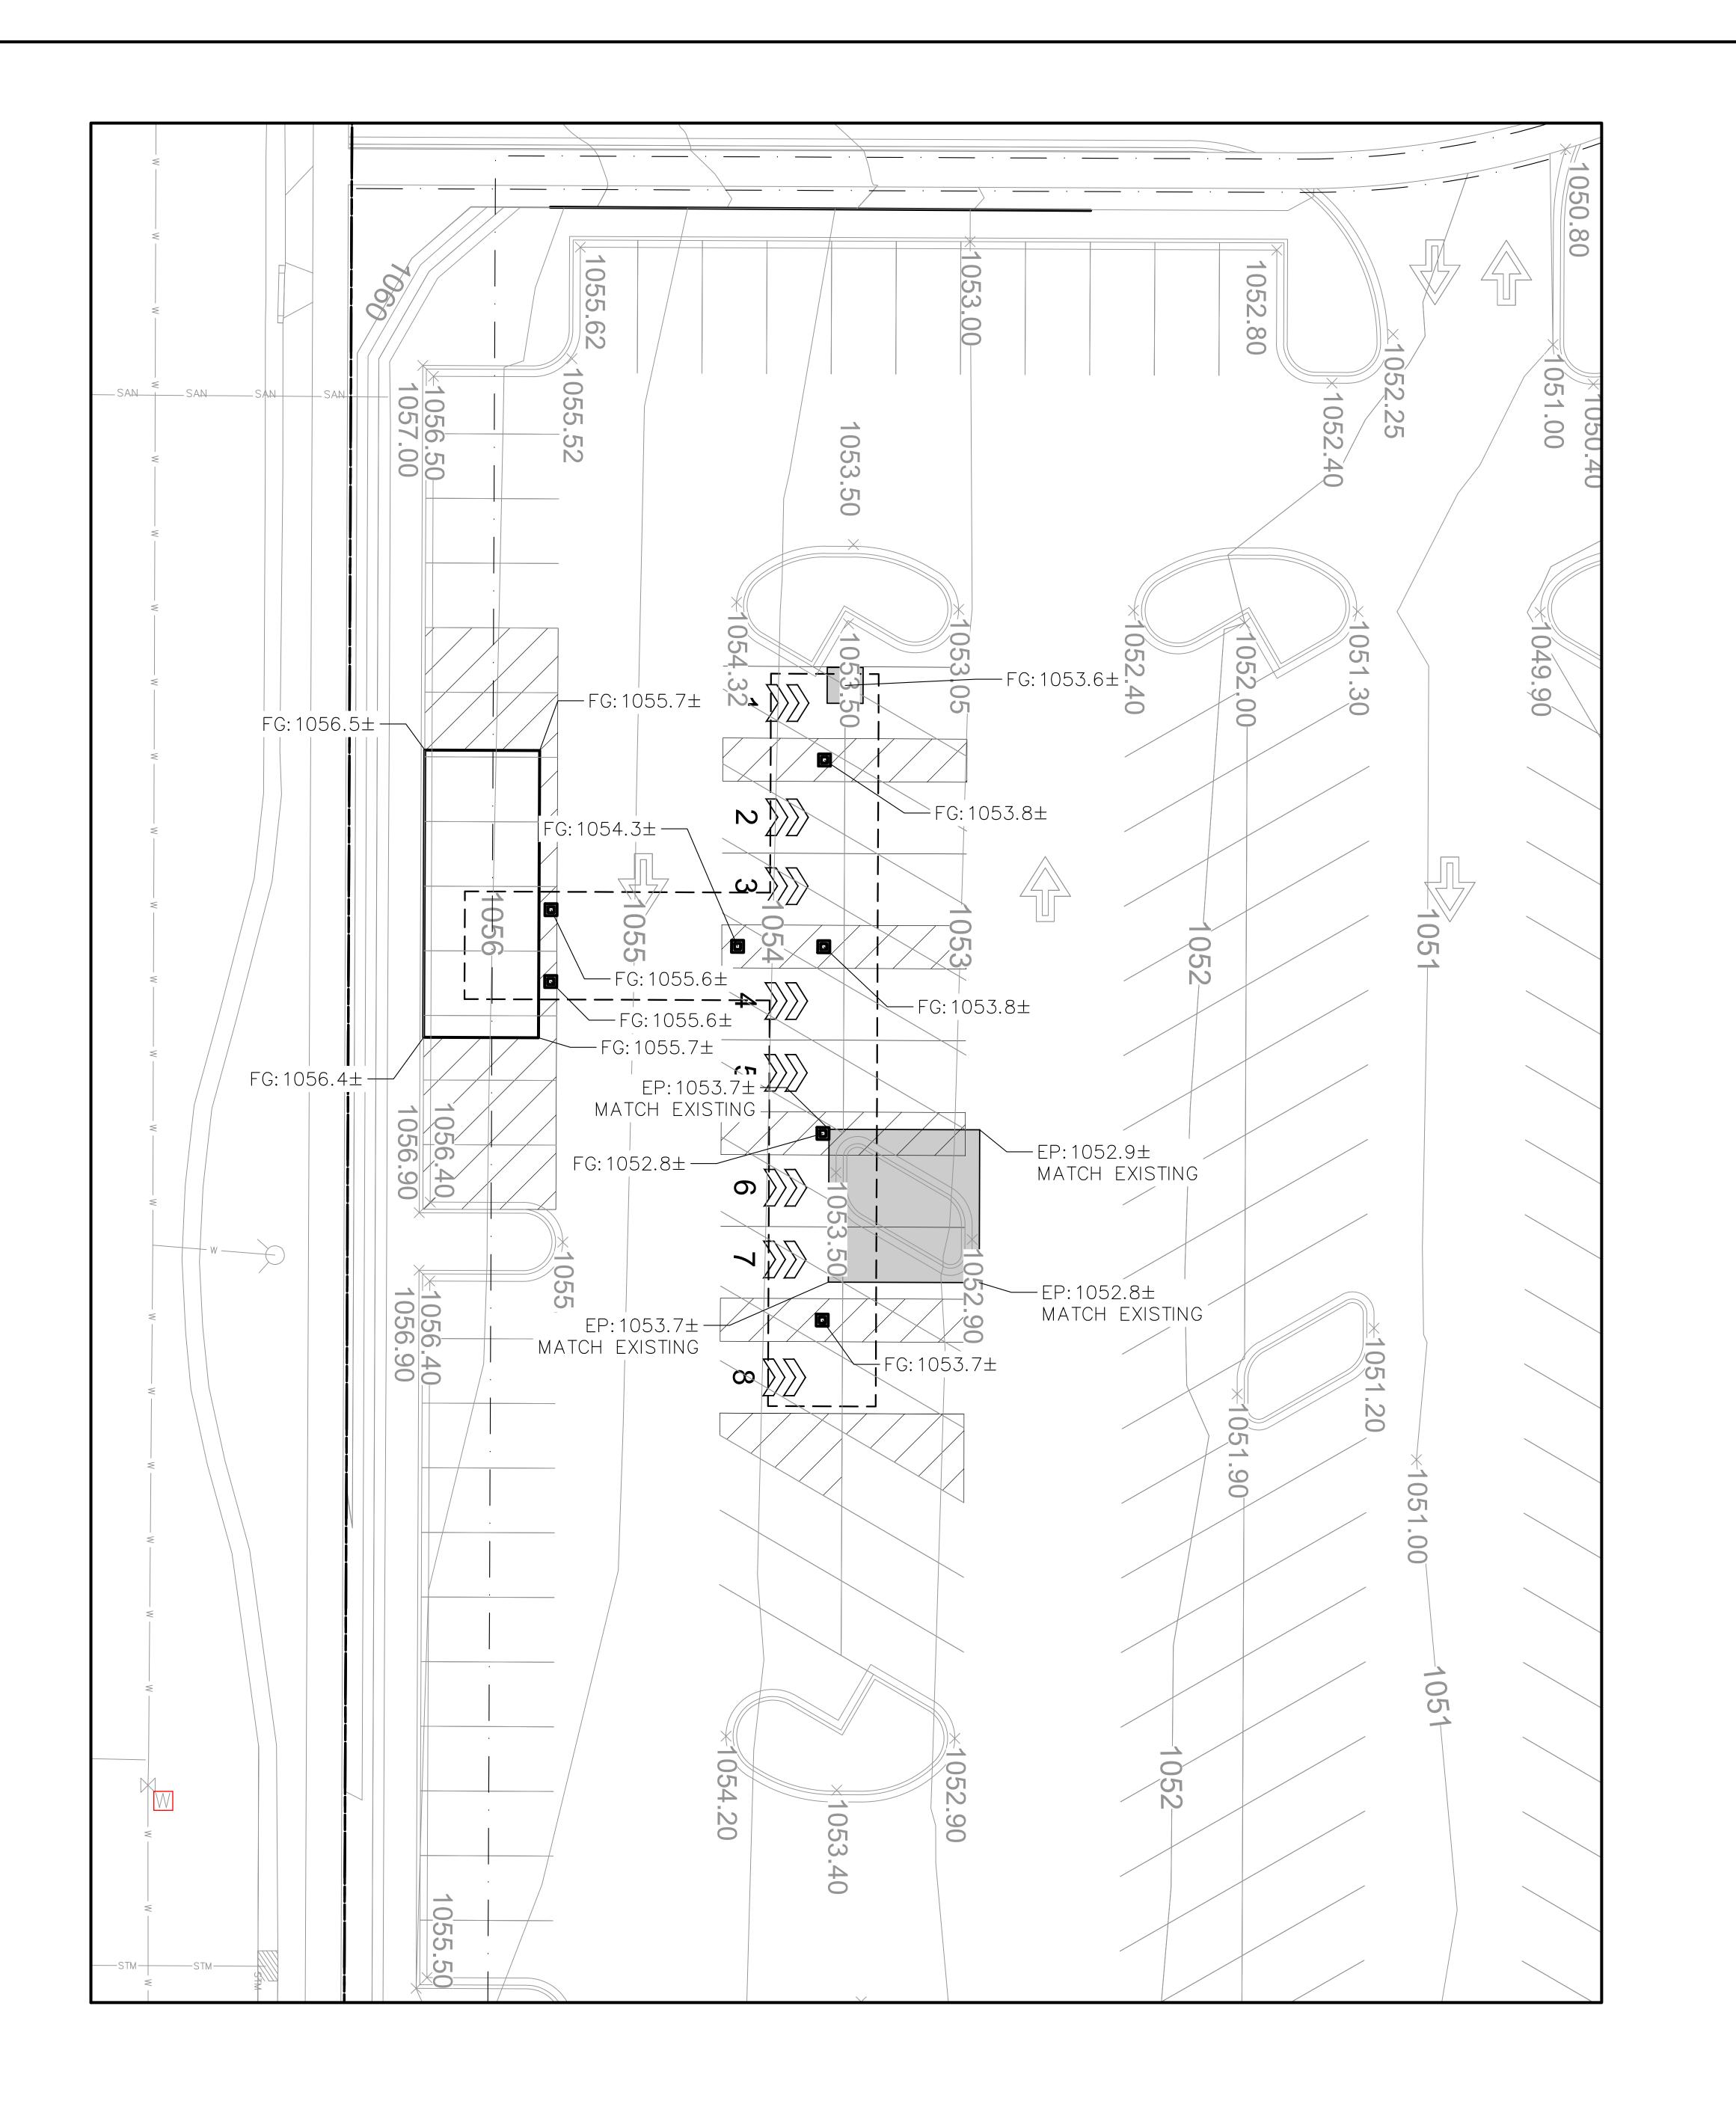

### **GRADING NOTES**

1. PROVIDE AND MAINTAIN EROSION CONTROL DEVICES WHERE SHOWN ON PLANS. DEVICES TO REMAIN IN PLACE UNTIL PAVEMENT AND INTAKES ARE CONSTRUCTED AND UNTIL A LAWN IS ESTABLISHED.

3. IN AREAS TO RECEIVE ADDITIONAL FILL OVER EXISTING FILL MATERIALS, REMOVE TOP 12" OF MATERIAL AND SCARIFY AND RECOMPACT THE NEXT 9" OF RESULTING SUBGRADE. COMPACT TO 95% STANDARD PROCTOR DENSITY. SUBSEQUENT FILL TO BE COMPACTED TO 95% STANDARD PROCTOR DENSITY TO WITHIN 1.0' OF FINAL SUBGRADE. THE FINAL 1.0' OF FILL TO BE COMPACTED TO 98% STANDARD PROCTOR.

4. SCARIFY AND RECOMPACT THE TOP 9" OF SUBGRADE IN ALL CUT AREAS AFTER ROUGH GRADING IS COMPLETED. COMPACT THE ENTIRE PAVING AND BUILDING SUBGRADE TO 95% STANDARD PROCTOR DENSITY TO WITHIN 1.0' OF FINAL SUBGRADE. THE FINAL 1.0' OF FILL TO BE COMPACTED TO 98% STANDARD PROCTOR.

5. PROVIDE MINIMUM OF 1.0' OF COMPACTED NON-EXPANSIVE COHESIVE SOIL BENEATH ALL PAVEMENTS.

6. ALL FILL AND BACKFILL MATERIALS SHALL BE APPROVED BY THE SOILS ENGINEER. PLACE ALL FILLS IN LIFTS OF NINE INCHES OR LESS LOOSE THICKNESS. ALL FILL SHALL BE PLACED BETWEEN 1% BELOW AND 4% ABOVE OPTIMUM MOISTURE CONTENT.

7. FINISH CONTOURS SHOWN ARE TO TOP OF PAVEMENT OR TO TOP OF TOPSOIL. SEE BUILDING PLANS AND CONSTRUCTION DETAILS FOR FINISHED SUBGRADE BELOW FINISHED FLOOR AND PAVEMENT SECTIONS.

8. SCARIFY SUBGRADE TO DEPTH OF 3" WHERE TOPSOIL IS SCHEDULED. SCARIFY IN AREAS WHERE EQUIPMENT USED FOR HAULING AND SPREADING TOPSOIL HAS CAUSED COMPACTED SUBSOIL.

9. CONTRACTOR SHALL BE RESPONSIBLE FOR LOCATING ALL UTILITIES PRIOR TO CONSTRUCTION, BOTH PUBLIC AND PRIVATE.

10. SPOT ELEVATIONS ARE SHOWN AT TOP OF FINISH GRADE, ADD 6" TO ELEVATIONS IN PAVED AREAS TO FIND TOP OF CURB ELEVATIONS.

HY-VEE, INC. 5820 WESTOWN PARKWAY WEST DES MOINES, IOWA 50266

P 515-267-2800

F 515-267-2935

2920 FITC

DRAWN BY

**LEGEND** 

PROPERTY LINE BUILDING OVERHANG EDGE OF PAVEMENT STANDARD CURB AND GUTTER

REJECT CURB AND GUTTER MOUNTABLE CURB AND GUTTER ASPHALT PAVEMENT CONCRETE PAVEMENT

959 PROPOSED 1 FOOT CONTOUR 960-PROPOSED 5 FOOT CONTOUR - - 959 - EXISTING 1 FOOT CONTOUR ---- 960----- EXISTING 5 FOOT CONTOUR DRAINAGE DIRECTION FG: XXX.XX SPOT ELEVATION FOT ELEVATION

EP - EDGE OF PAVEMENT

FG - FINISH GRADE

EC - EDGE OF CONCRETE

BOC - BACK OF CURB

MATCH - MATCH EXISTING GRADE

HP - HIGH POINT SW - SIDEWALK


SCALE IN FEET

SHEET

**GRADING PLAN** 

DRAWN BY DATE CEJ 06-23-2020 SCALE AS NOTED

C3.0

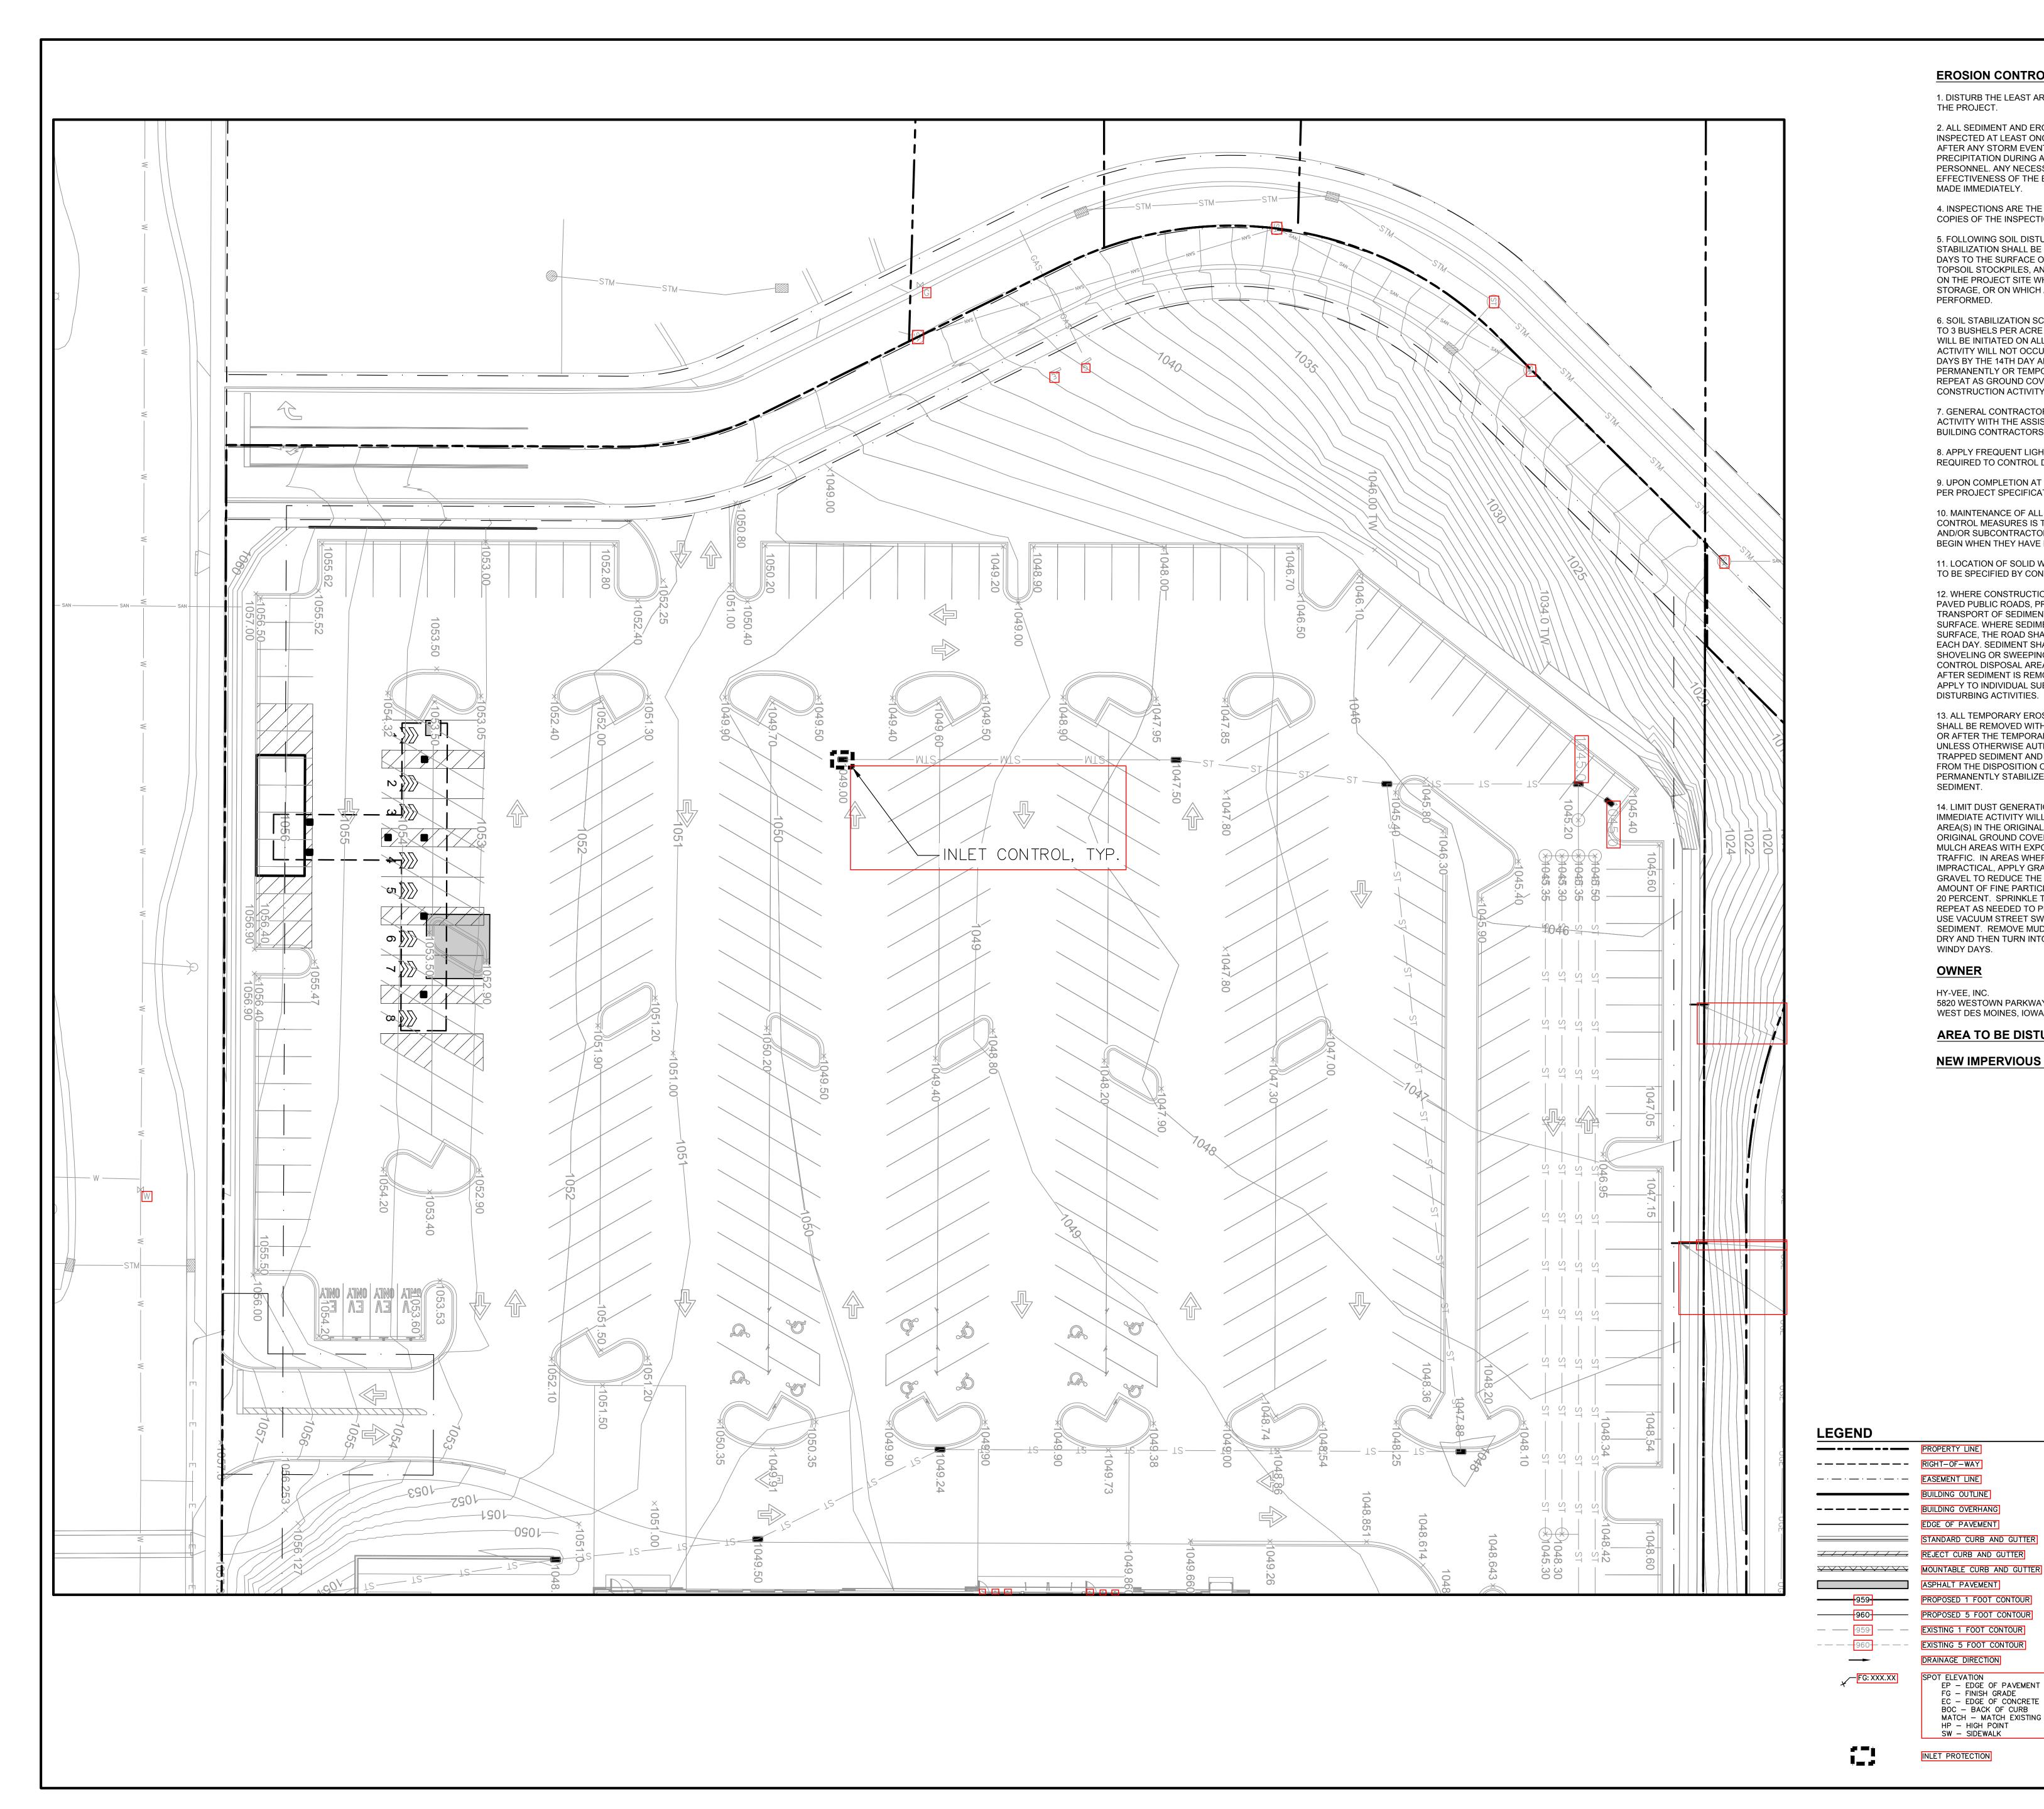

### **EROSION CONTROL NOTES**

1. DISTURB THE LEAST AREA POSSIBLE TO COMPLETE THE SCOPE OF THE PROJECT.

2. ALL SEDIMENT AND EROSION CONTROL PRACTICES WILL BE INSPECTED AT LEAST ONCE EVERY SEVEN (7) CALENDAR DAYS AND AFTER ANY STORM EVENT OF GREATER THAN 0.5 INCHES OF PRECIPITATION DURING ANY 24-HOUR PERIOD BY RESPONSIBLE PERSONNEL. ANY NECESSARY REPAIRS OR CLEANUP TO MAINTAIN THE EFFECTIVENESS OF THE BEST MANAGEMENT PRACTICES SHALL BE MADE IMMEDIATELY.

HY-VEE, INC.

P 515-267-2800

F 515-267-2935

5820 WESTOWN PARKWAY

WEST DES MOINES, IOWA 50266

4. INSPECTIONS ARE THE RESPONSIBILITY OF THE CONTRACTOR. COPIES OF THE INSPECTION FORMS SHALL BE SENT TO HY-VEE.

5. FOLLOWING SOIL DISTURBANCE, PERMANENT OR TEMPORARY STABILIZATION SHALL BE COMPLETED WITHIN SEVEN (7) CALENDAR DAYS TO THE SURFACE OF ALL PERIMETER SEDIMENT CONTROLS, TOPSOIL STOCKPILES, AND ANY OTHER DISTURBED OR GRADED AREAS ON THE PROJECT SITE WHICH ARE NOT BEING USED FOR MATERIAL STORAGE, OR ON WHICH ACTUAL EARTH MOVING ACTIVITIES ARE BEING PERFORMED.

6. SOIL STABILIZATION SCHEDULE TEMPORARY SEEDING WITH OATS - 2 TO 3 BUSHELS PER ACRE - AND MULCH ALL SLOPES 4:1 AND STEEPER WILL BE INITIATED ON ALL DISTURBED AREAS WHERE CONSTRUCTION ACTIVITY WILL NOT OCCUR FOR A PERIOD OF MORE THAN 21 CALENDAR DAYS BY THE 14TH DAY AFTER CONSTRUCTION ACTIVITY HAS PERMANENTLY OR TEMPORARILY CEASED. THIS SEQUENCE SHALL REPEAT AS GROUND COVER IS REMOVED BY SUBSEQUENT CONSTRUCTION ACTIVITY.

7. GENERAL CONTRACTOR SHALL IMPLEMENT ALL POLLUTION PLAN ACTIVITY WITH THE ASSISTANCE OF THE UTILITY SUBCONTRACTORS, BUILDING CONTRACTORS AND SUPPLIERS.

8. APPLY FREQUENT LIGHT WATERING TO GROUND SURFACE, AS REQUIRED TO CONTROL DUST.

9. UPON COMPLETION AT CONSTRUCTION, SOD ALL DISTURBED AREAS PER PROJECT SPECIFICATIONS.

10. MAINTENANCE OF ALL TEMPORARY AND PERMANENT EROSION CONTROL MEASURES IS THE RESPONSIBILITY OF THE CONTRACTOR AND/OR SUBCONTRACTORS. CLEANING OF CONTROL DEVICES SHALL BEGIN WHEN THEY HAVE LOST 50% OF THEIR CAPACITY.

11. LOCATION OF SOLID WASTE CONTAINER AND PORTABLE RESTROOM TO BE SPECIFIED BY CONTRACTOR.

12. WHERE CONSTRUCTION VEHICLE ACCESS ROUTES INTERSECT PAVED PUBLIC ROADS, PROVISIONS SHALL BE MADE TO MINIMIZE THE TRANSPORT OF SEDIMENT BY VEHICULAR TRACKING ONTO THE PAVED SURFACE. WHERE SEDIMENT IS TRANSPORTED ONTO A PUBLIC ROAD SURFACE, THE ROAD SHALL BE CLEANED THOROUGHLY AT THE END OF EACH DAY. SEDIMENT SHALL BE REMOVED FROM THE ROADS BY SHOVELING OR SWEEPING AND TRANSPORTED TO A SEDIMENT CONTROL DISPOSAL AREA. STREET WASHING SHALL BE ALLOWED ONLY AFTER SEDIMENT IS REMOVED IN THIS MANNER. THIS PROVISION SHALL APPLY TO INDIVIDUAL SUBDIVISION LOTS AS WELL AS TO LARGER LAND DISTURBING ACTIVITIES.

13. ALL TEMPORARY EROSION AND SEDIMENT CONTROL MEASURES SHALL BE REMOVED WITHIN 30 DAYS AFTER FINAL SITE STABILIZATION OR AFTER THE TEMPORARY MEASURES ARE NO LONGER NEEDED, UNLESS OTHERWISE AUTHORIZED BY THE IMPLEMENTING AGENCY. TRAPPED SEDIMENT AND THE DISTURBED SOIL AREAS RESULTING FROM THE DISPOSITION OF TEMPORARY MEASURES SHALL BE PERMANENTLY STABILIZED TO PREVENT FURTHER EROSION AND

14. LIMIT DUST GENERATION BY CLEARING ONLY THOSE AREAS WHERE IMMEDIATE ACTIVITY WILL TAKE PLACE, LEAVING THE REMAINING AREA(S) IN THE ORIGINAL CONDITION, IF STABLE. MAINTAIN THE ORIGINAL GROUND COVER AS LONG AS PRACTICAL. VEGETATE OR MULCH AREAS WITH EXPOSED SOILS THAT WILL NOT RECEIVE VEHICLE TRAFFIC. IN AREAS WHERE PLANTING, MULCHING OR PAVING IS IMPRACTICAL, APPLY GRAVEL OR LANDSCAPING ROCK. ADD SURFACE GRAVEL TO REDUCE THE SOURCE OF DUST EMISSION. LIMIT THE AMOUNT OF FINE PARTICLES (THOSE SMALLER THAN 0.075MM) TO 10 TO 20 PERCENT. SPRINKLE THE SITE WITH WATER UNTIL SURFACE IS WET. REPEAT AS NEEDED TO PREVENT CARRYOUT OF MUD ONTO STREET. USE VACUUM STREET SWEEPERS TO SWEEP UP ANY TRACKED SEDIMENT. REMOVE MUD AND OTHER DIRT PROMPTLY SO IT DOES NOT DRY AND THEN TURN INTO DUST. LIMIT DUST CAUSING WORK ON WINDY DAYS.

DRAINAGE DIRECTION

SW - SIDEWALK

INLET PROTECTION

EP - EDGE OF PAVEMENT
FG - FINISH GRADE
EC - EDGE OF CONCRETE
BOC - BACK OF CURB

SPOT ELEVATION

HY-VEE, INC. 5820 WESTOWN PARKWAY

WEST DES MOINES, IOWA, 50266

AREA TO BE DISTURBED: 0.006 AC OR 267 SF

NEW IMPERVIOUS AREA: 0.003 AC OR 143 SF

DRAWN BY

20


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SCALE IN FEET

MATCH — MATCH EXISTING GRADE HP — HIGH POINT Toll Free (800) 242-8511

**EROSION CONTROL** PLAN

> DRAWN BY DATE CEJ 06-23-2020 SCALE AS NOTED SHEET

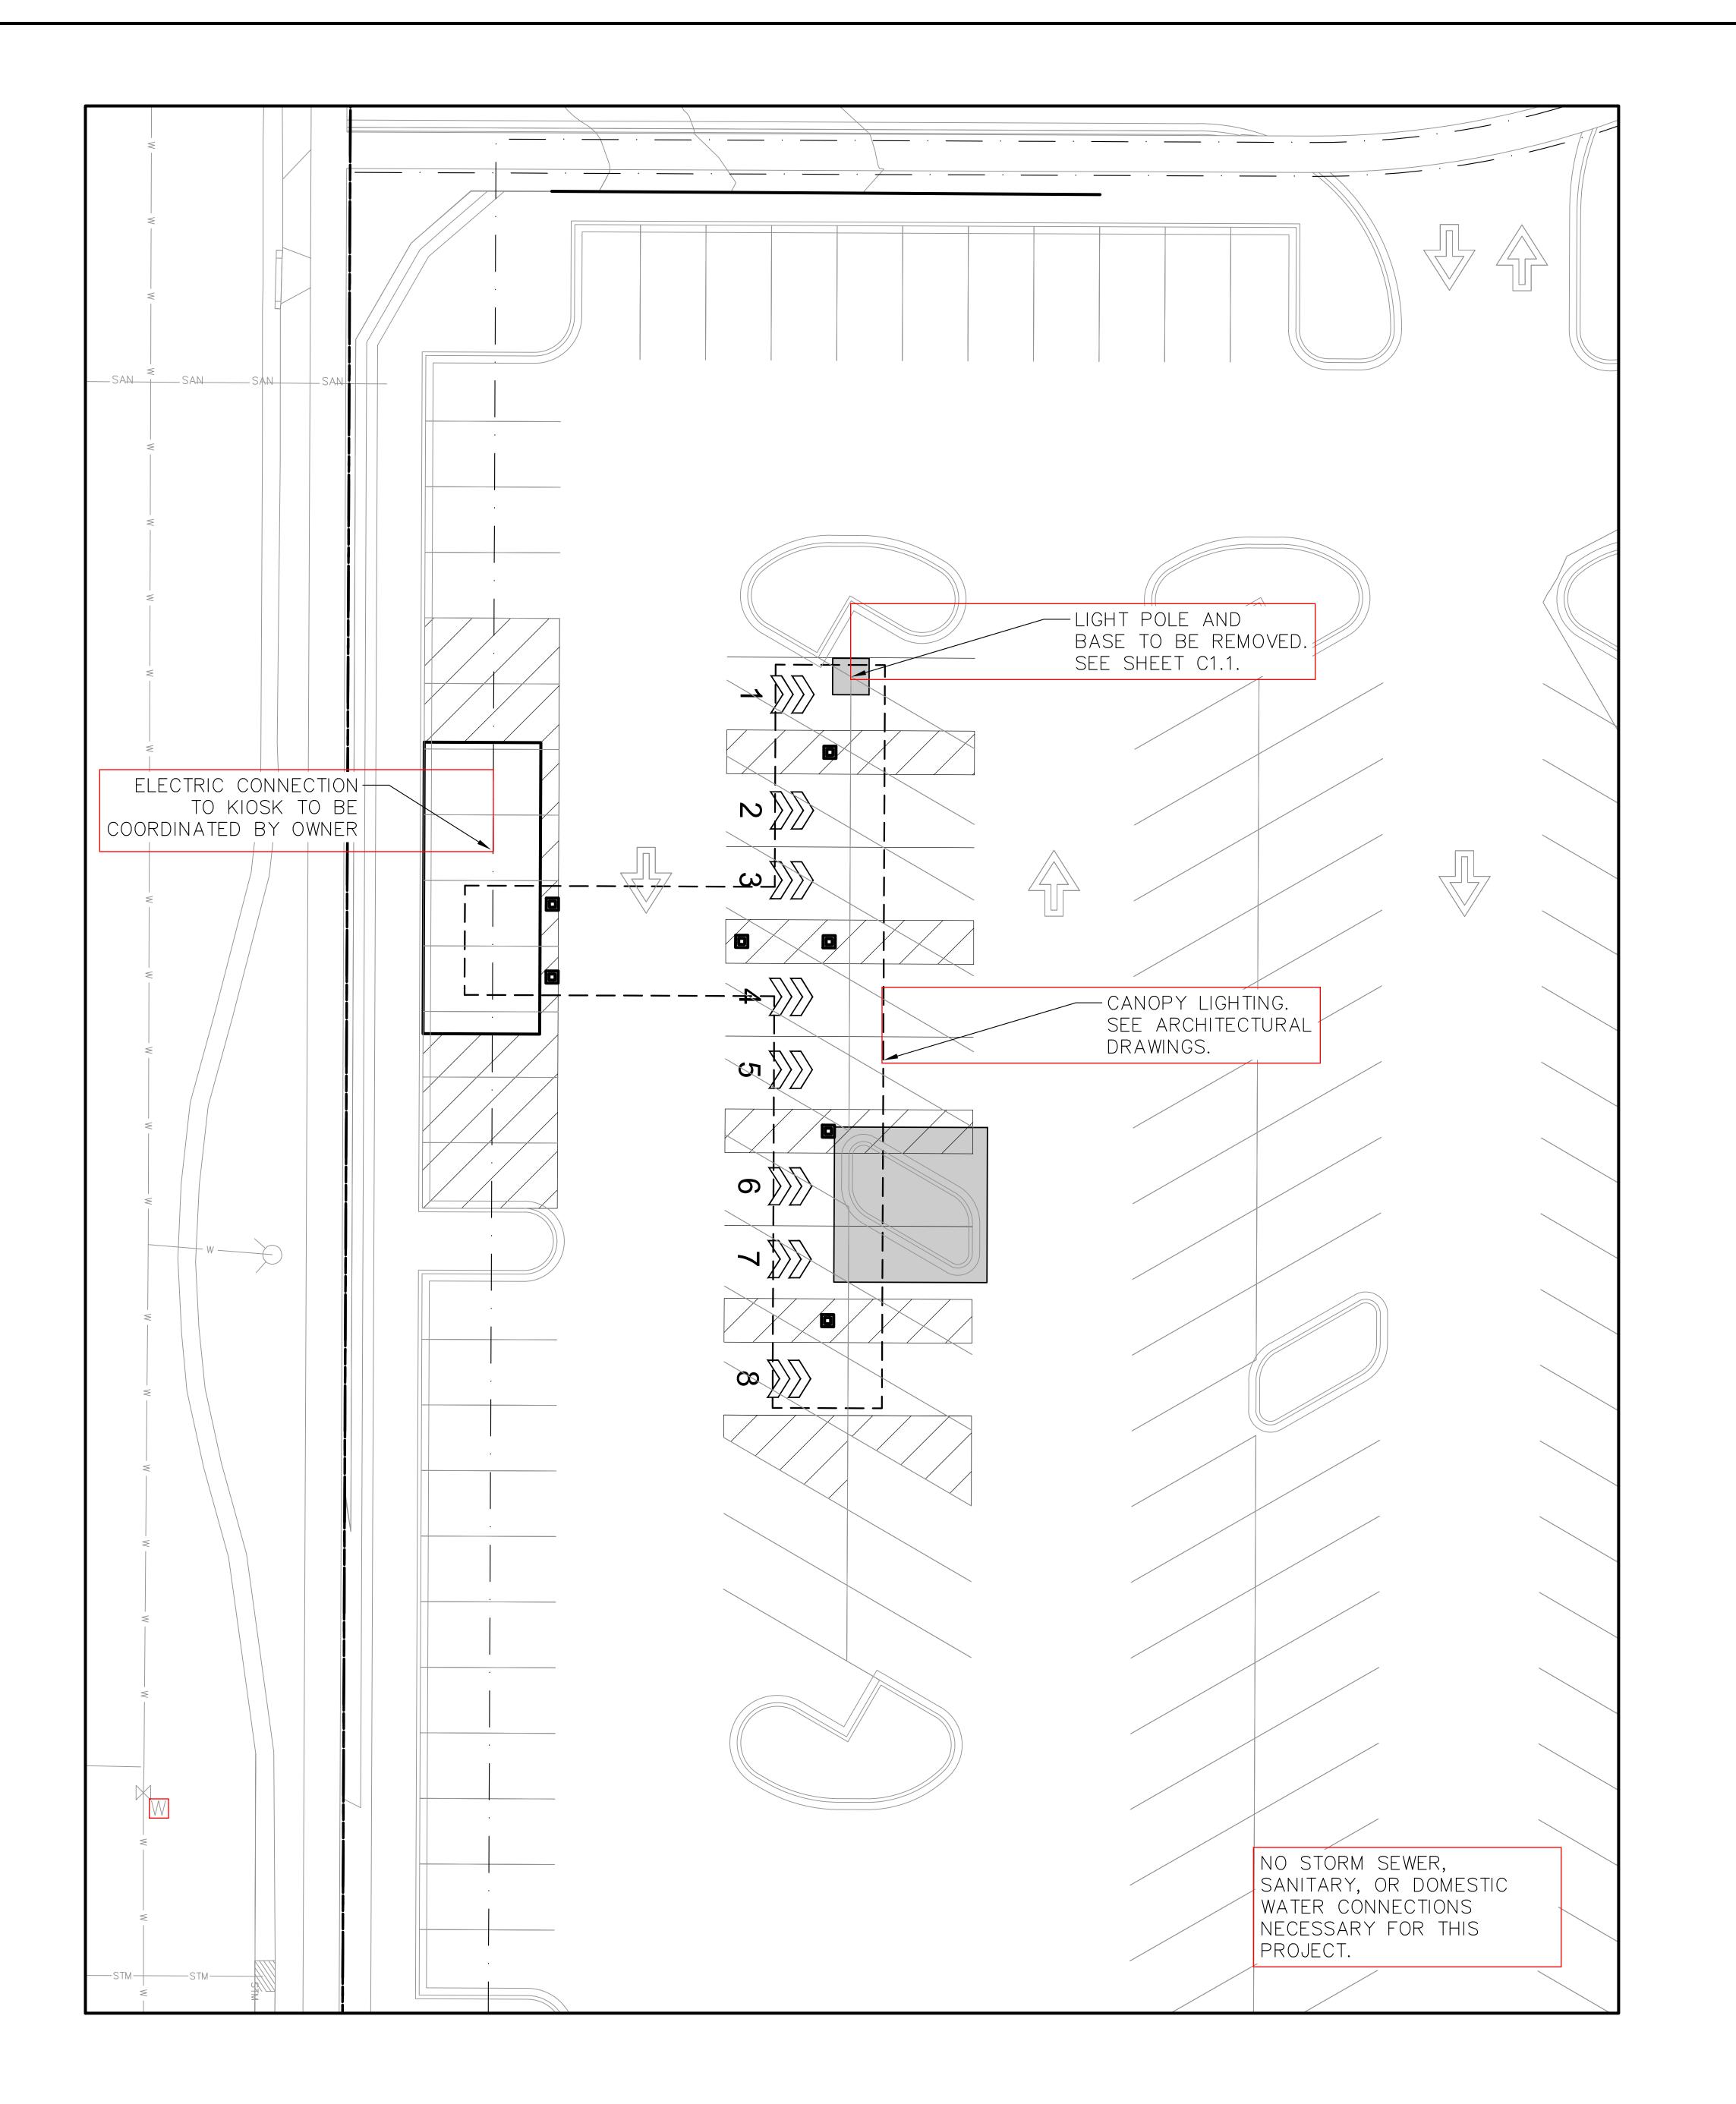

### **UTILITY NOTES**

1. PROTECT EXISTING UTILITIES WHICH ARE TO REMAIN. THE LOCATIONS OF ALL UTILITIES INDICATED ON THE PLANS ARE TAKEN FROM EXISTING RECORDS. THE EXACT LOCATION AND ELEVATION OF ALL UTILITIES MUST BE DETERMINED BY THE CONTRACTOR. IT SHALL BE THE DUTY OF THE CONTRACTOR TO ASCERTAIN WHETHER ANY ADDITIONAL FACILITIES OTHER THAN THOSE SHOWN ON THE PLAN MAY BE PRESENT.

2. SEE DETAILS FOR UTILITY TRENCH CONSTRUCTION REQUIREMENTS. GEOTECHNICAL ENGINEER TO OBSERVE UTILITY TRENCH BACKFILL AND COMPACTION PROCEDURES.

### SITE LIGHTING NOTES

1. NOTIFICATION: CONTRACTOR SHALL NOTIFY HY-VEE A MINIMUM OF 60 DAYS PRIOR TO THE ANTICIPATED DATE OF INSTALLATION.

2. MATERIAL: OWNER WILL PURCHASE SITE LIGHTING MATERIALS. THOSE MATERIALS INCLUDE THE FOLLOWING: FIXTURES WITH LAMPS, TENON, POLE, ANCHOR BOLTS AND ANCHOR BOLT TEMPLATE. THE GENERAL CONTRACTOR IS RESPONSIBLE FOR RECEIVING, UNLOADING, AND VERIFYING QUANTITIES AND CONDITIONS OF THESE MATERIALS. INSPECT ALL PACKAGES FOR EXTERIOR DAMAGE BEFORE THE CARRIER LEAVES THE SITE, AND NOTIFY OWNER'S REPRESENTATIVE WITH INFORMATION ON THE SHIPMENT. RETURN A COPY OF THE PACKING LIST TO HY-VEE WITHIN SEVEN DAYS AFTER RECEIPT OF THE MATERIALS WITH NOTES REGARDING ANY DAMAGED GOODS OR THE LACK OF DAMAGE.

3. STORAGE OF MATERIALS: THE CONTRACTOR SHALL BE RESPONSIBLE FOR STORAGE AND PROTECTION OF ALL SITE LIGHTING MATERIALS, AND FOR INSTALLATION OF A FUNCTIONING SYSTEM WHICH MEETS HY-VEE'S APPROVAL.

4. CONDUIT AND WIRE: CONDUIT AND WIRE FOR SITE LIGHTING SHALL BE SIZED BY THE GENERAL CONTRACTOR AND APPROVED BY HY-VEE.

5. TESTING: A MINIMUM OF 30 DAYS BEFORE THE ONLINE AISLES OPENING, THE CONTRACTOR SHALL CONDUCT A 100 HOUR CONSECUTIVE TEST OF THE SITE LIGHTING SYSTEM. THIS IS INTENDED TO EXPOSE BURNED OUT LAMPS OR OTHER PROBLEMS WHILE ELECTRICIANS AND EQUIPMENT ARE STILL ON SITE. HY-VEE SHALL BE NOTIFIED WITH THE RESULTS OF THIS TEST AS SOON AS POSSIBLE SO REPLACEMENT MATERIALS CAN BE OBTAINED IF NECESSARY.

6. WIRING INFORMATION: SEE SHEET E-1 FOR CIRCUIT AND PANEL ASSIGNMENTS. A WIRING DIAGRAM FOR THE PARKING LOT LIGHTS IS REQUIRED FOR FUTURE REFERENCE. MAKE EDITS ON SITE UTILITY PLAN AND RETURN TO OWNER WITH AS-BUILT NOTES.

7. REFER TO FIXTURE AND POLE BASE DETAIL.

HY-VEE, INC. 5820 WESTOWN PARKWAY WEST DES MOINES, IOWA 50266 P 515-267-2800 F 515-267-2935


**LEGEND** 

PROPERTY LINE BUILDING OVERHANG REJECT CURB AND GUTTER MOUNTABLE CURB AND GUTTER 8" CONCRETE RIBBON CURB ASPHALT PAVEMENT HEAVY DUTY ASPHALT PAVEMENT CONCRETE PAVEMENT HEAVY DUTY CONCRETE PAVEMENT STORMWATER MANAGEMENT AREA RETAINING WALL · BOULDER WALL RAILING FENCE S SANITARY SEWER

> 8'x4'x2" INSULATION (PLAN VIEW) 8'x4'x2" INSULATION (PROFILE VIEW)

WATERMAIN


STORM SEWER

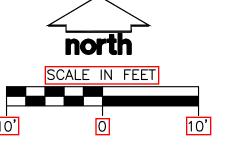



**UTILITY PLAN** 


DRAWN BY CEJ 06-23-2020 SCALE AS NOTED SHEET


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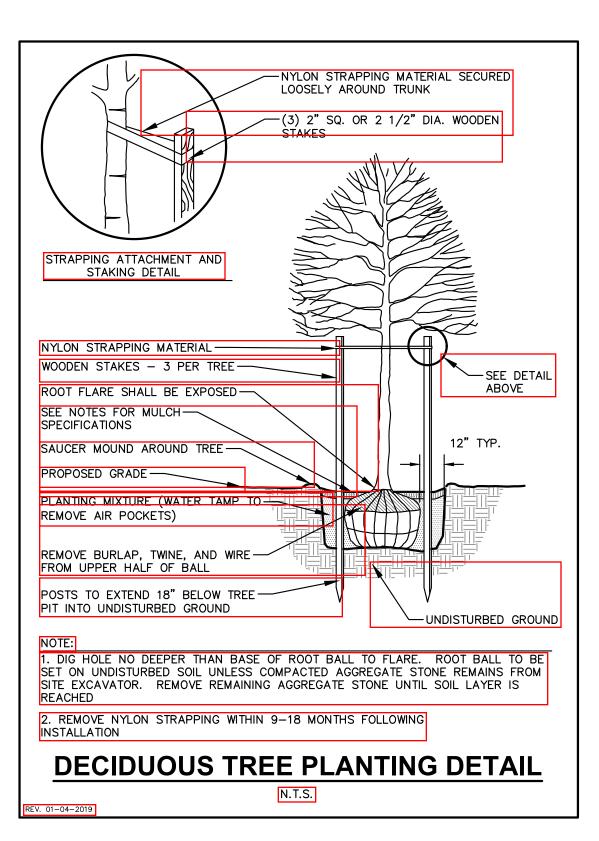


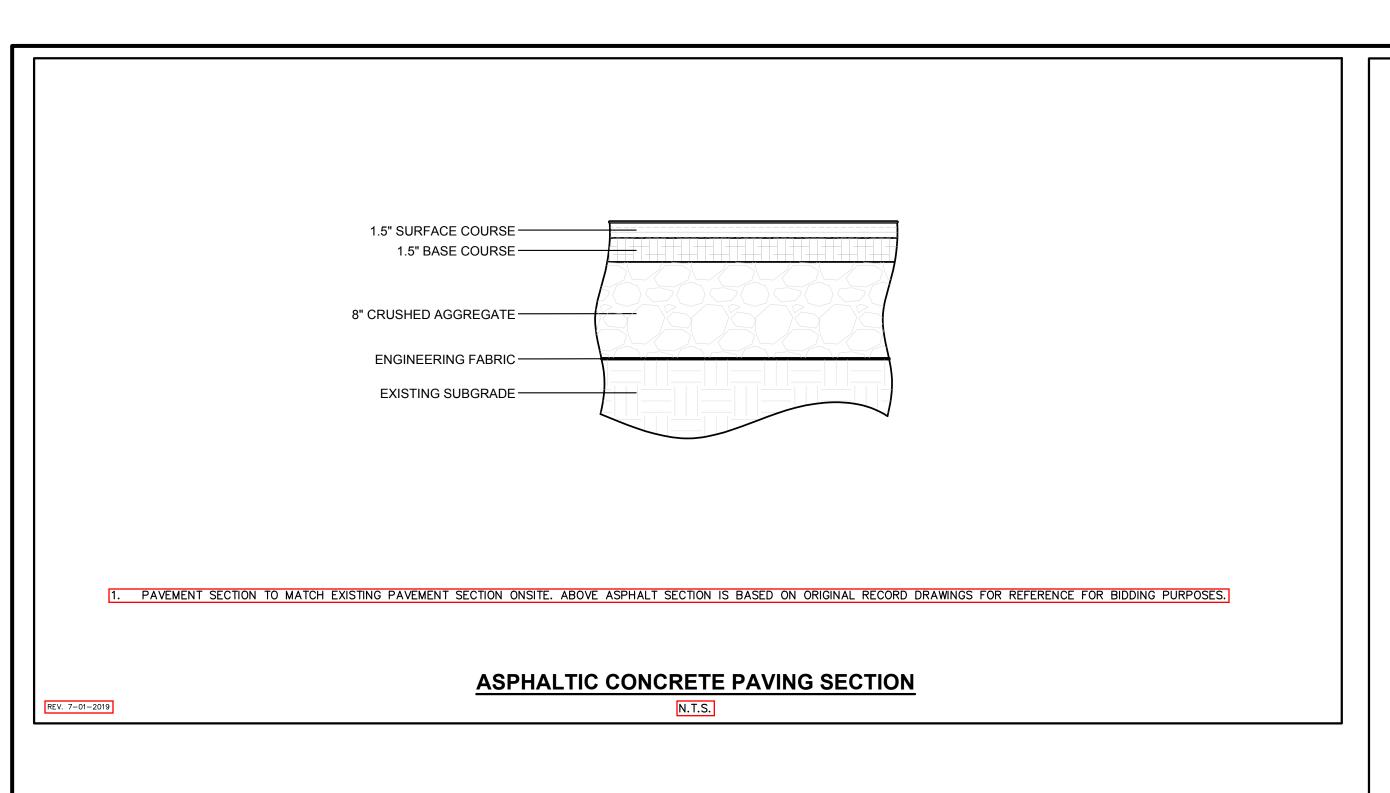


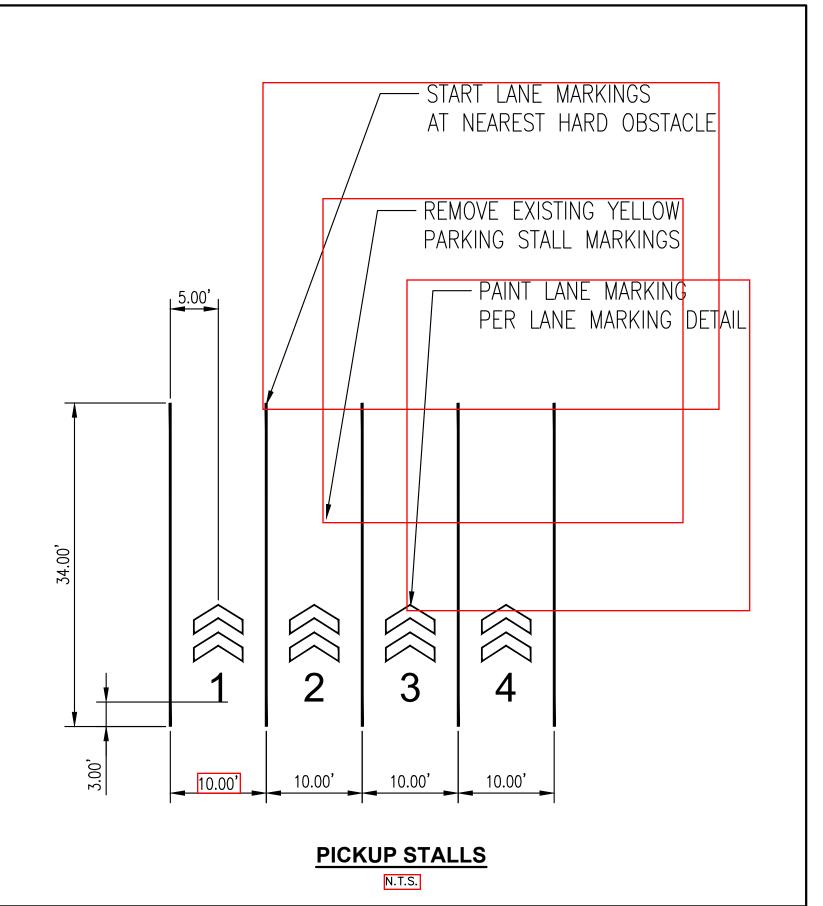

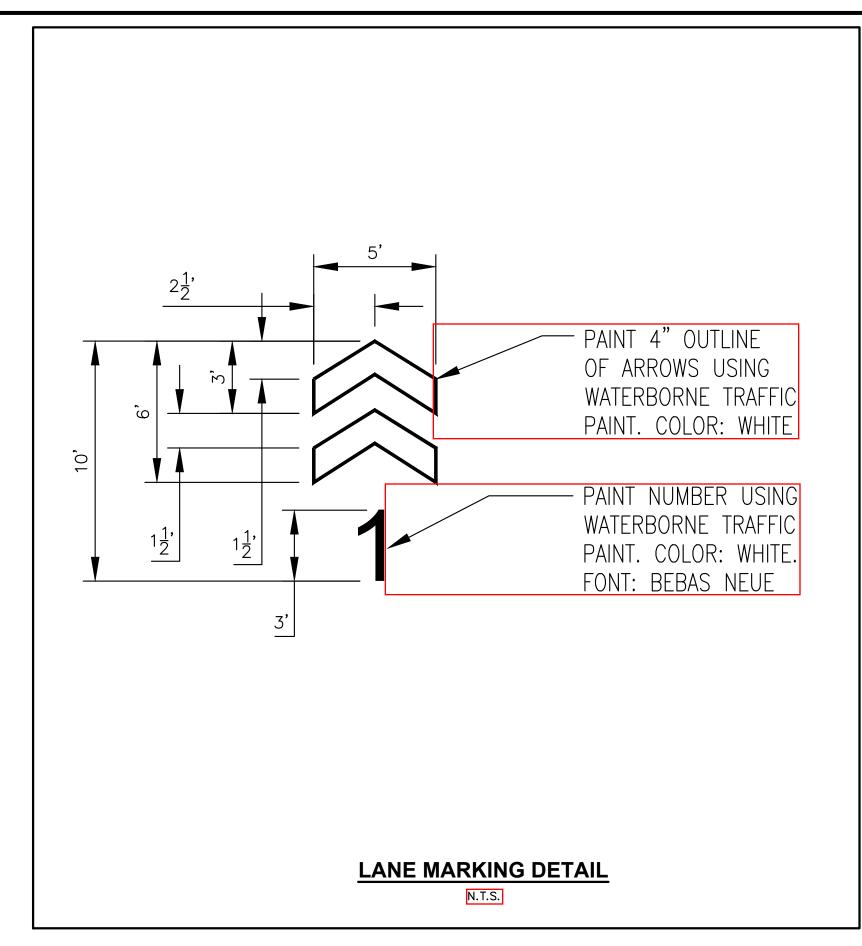

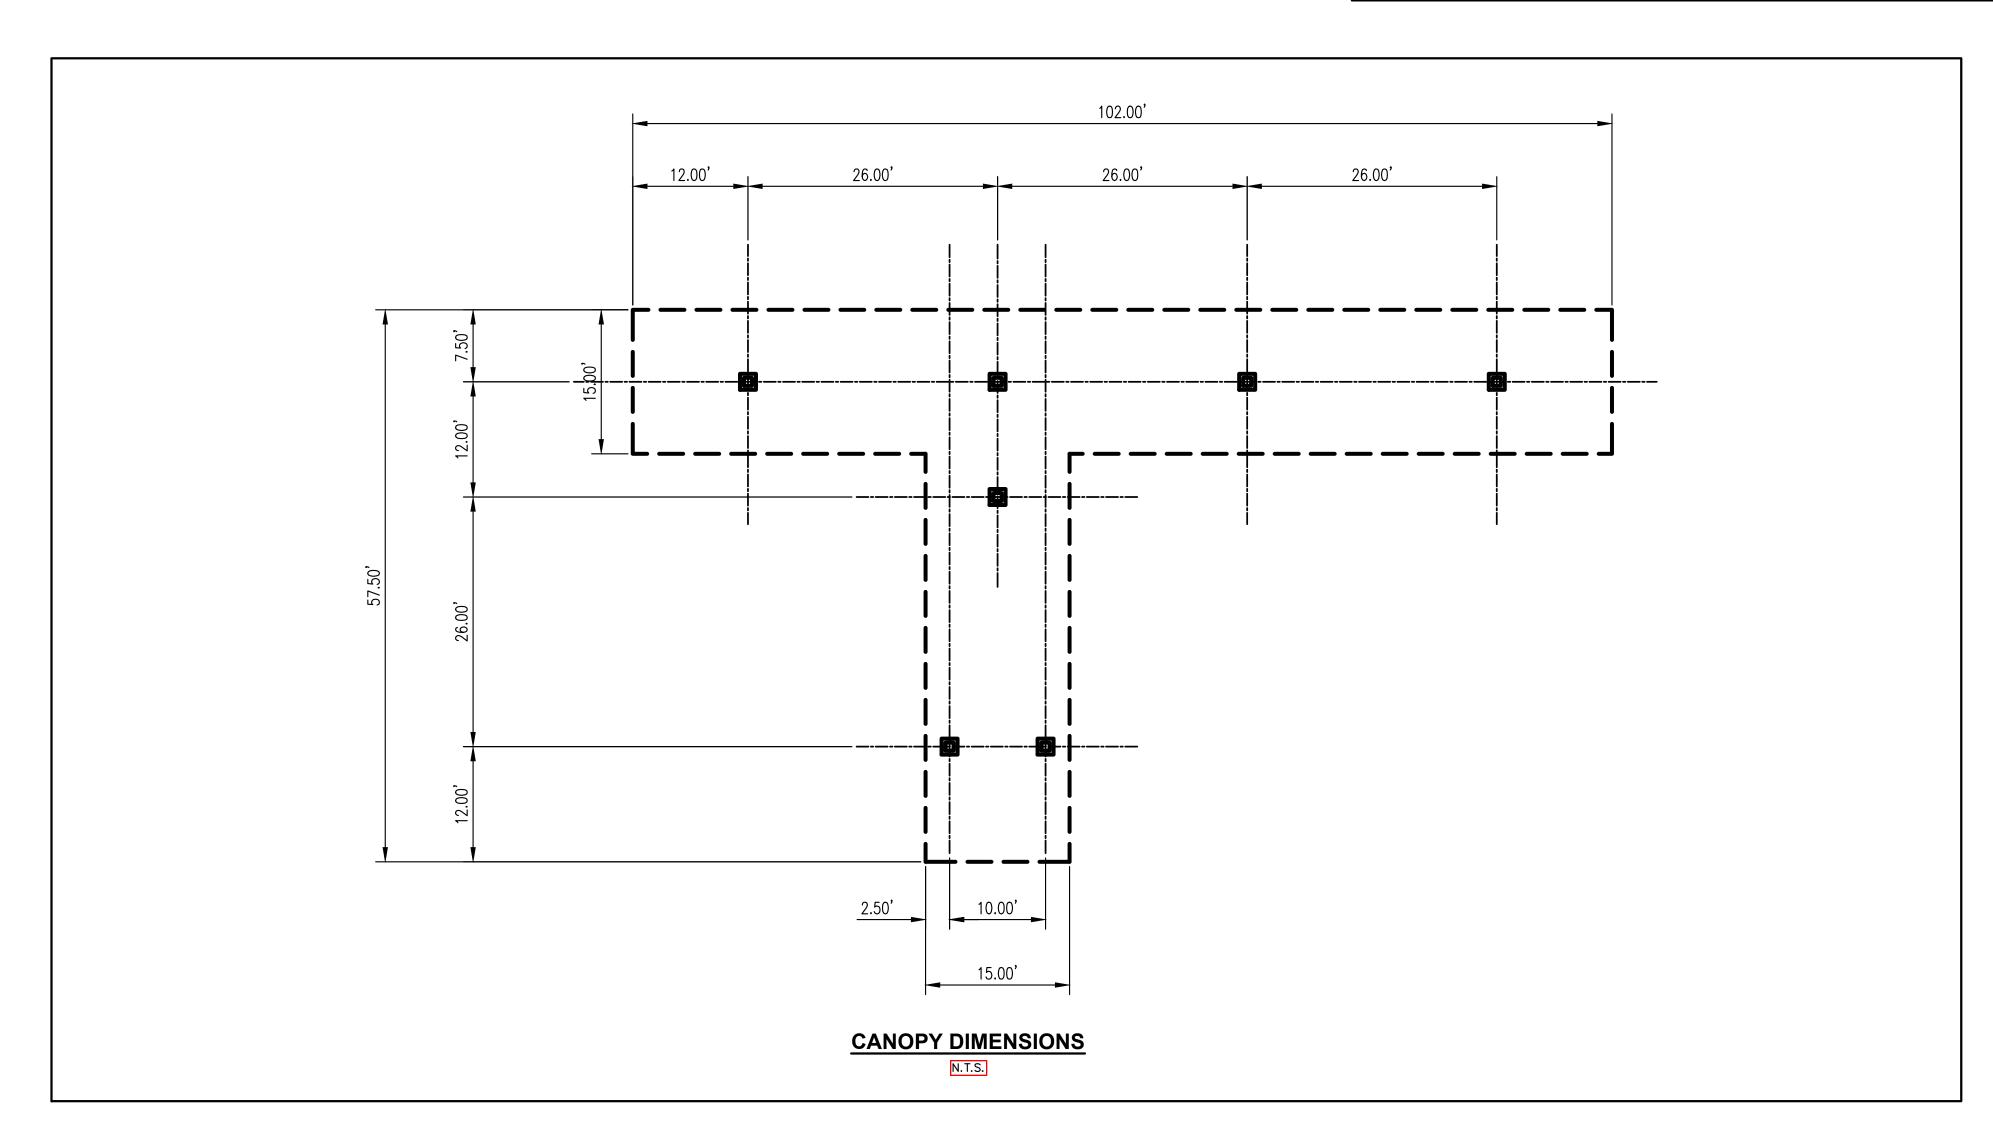

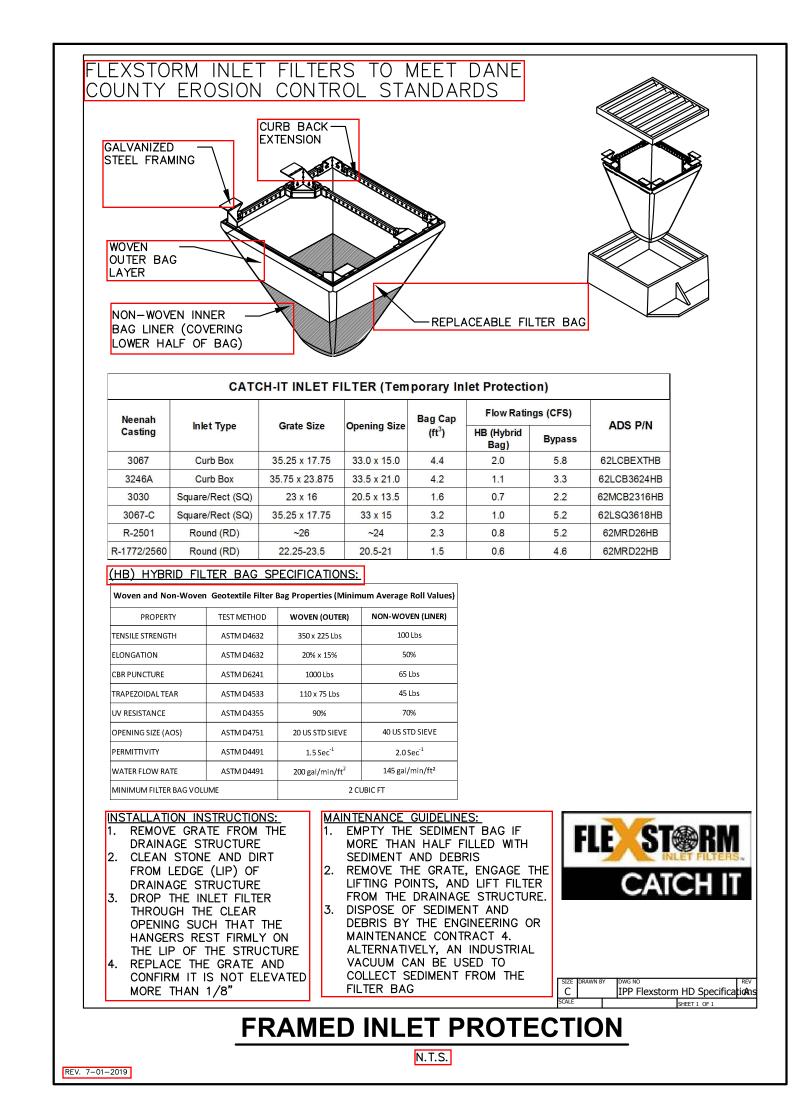

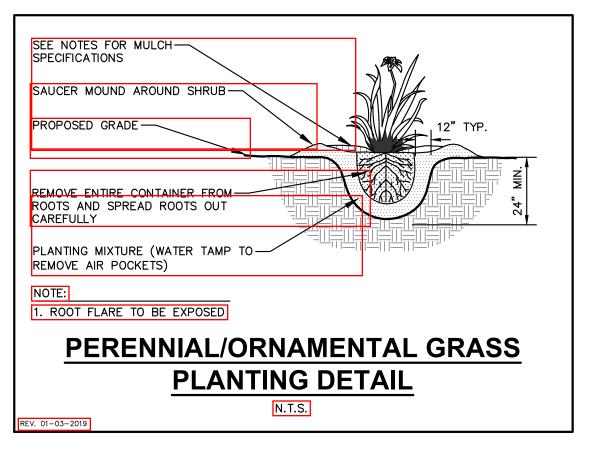



ONLINE AISLES KIOSK
2920 FITCHRONA ROAD
EITCHRIBG WI 53719

DATE

DRAWN BY

REVISIONS


**DETAILS** 


DRAWN BY DATE 06-23-2020

SCALE AS NOTED

SHEET

C5.0

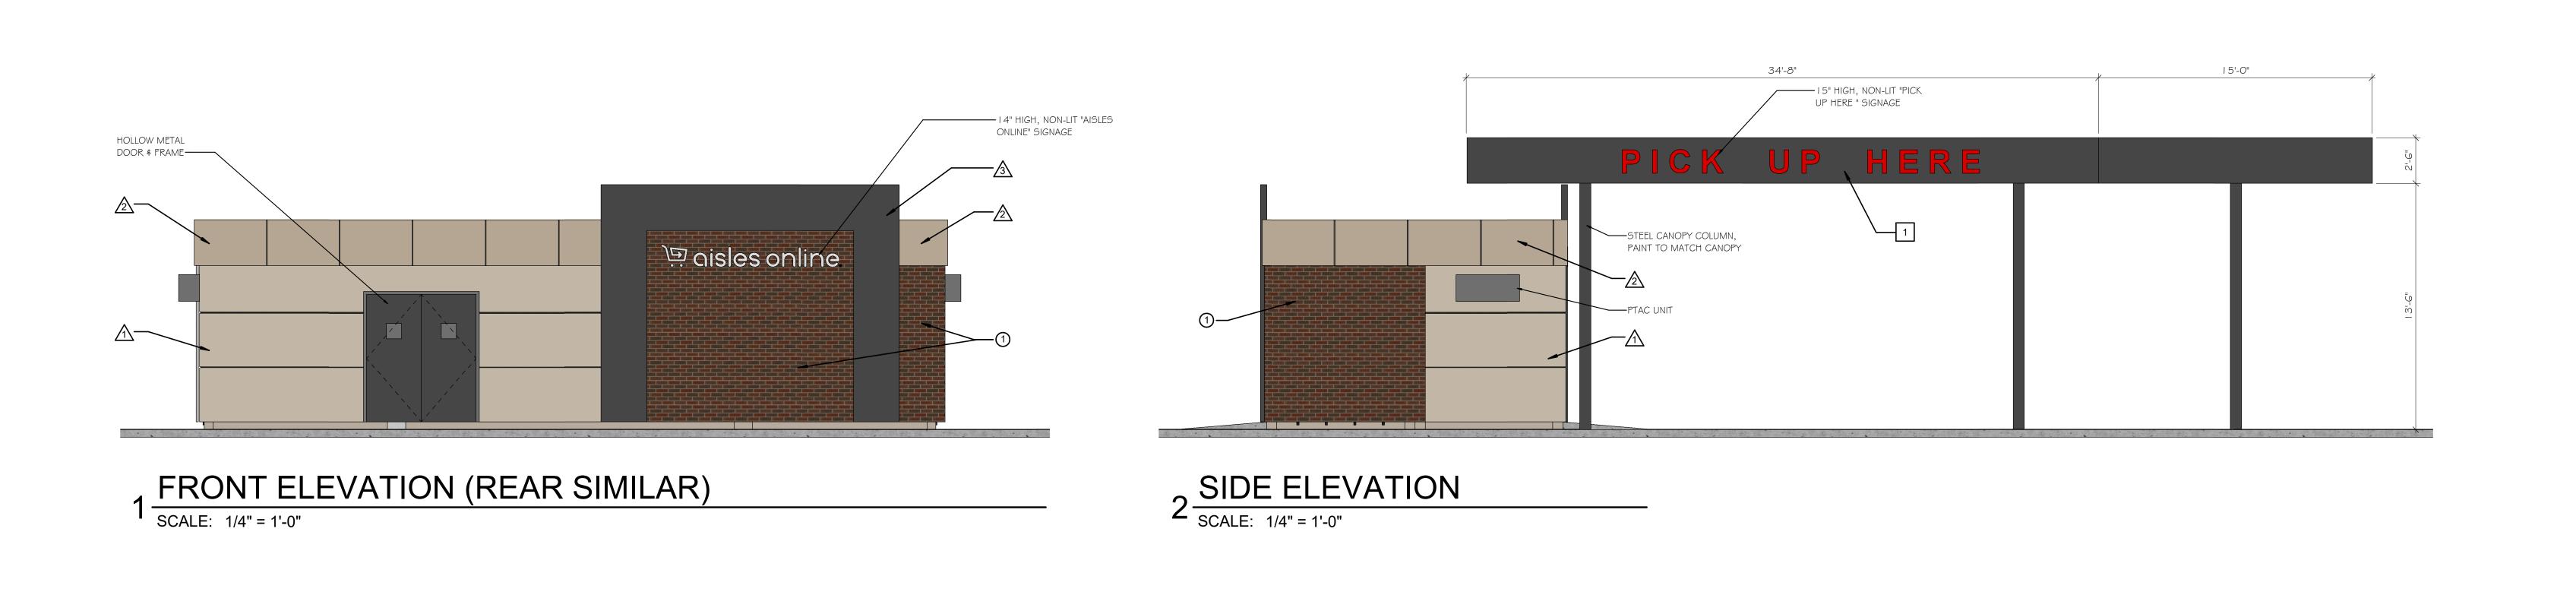

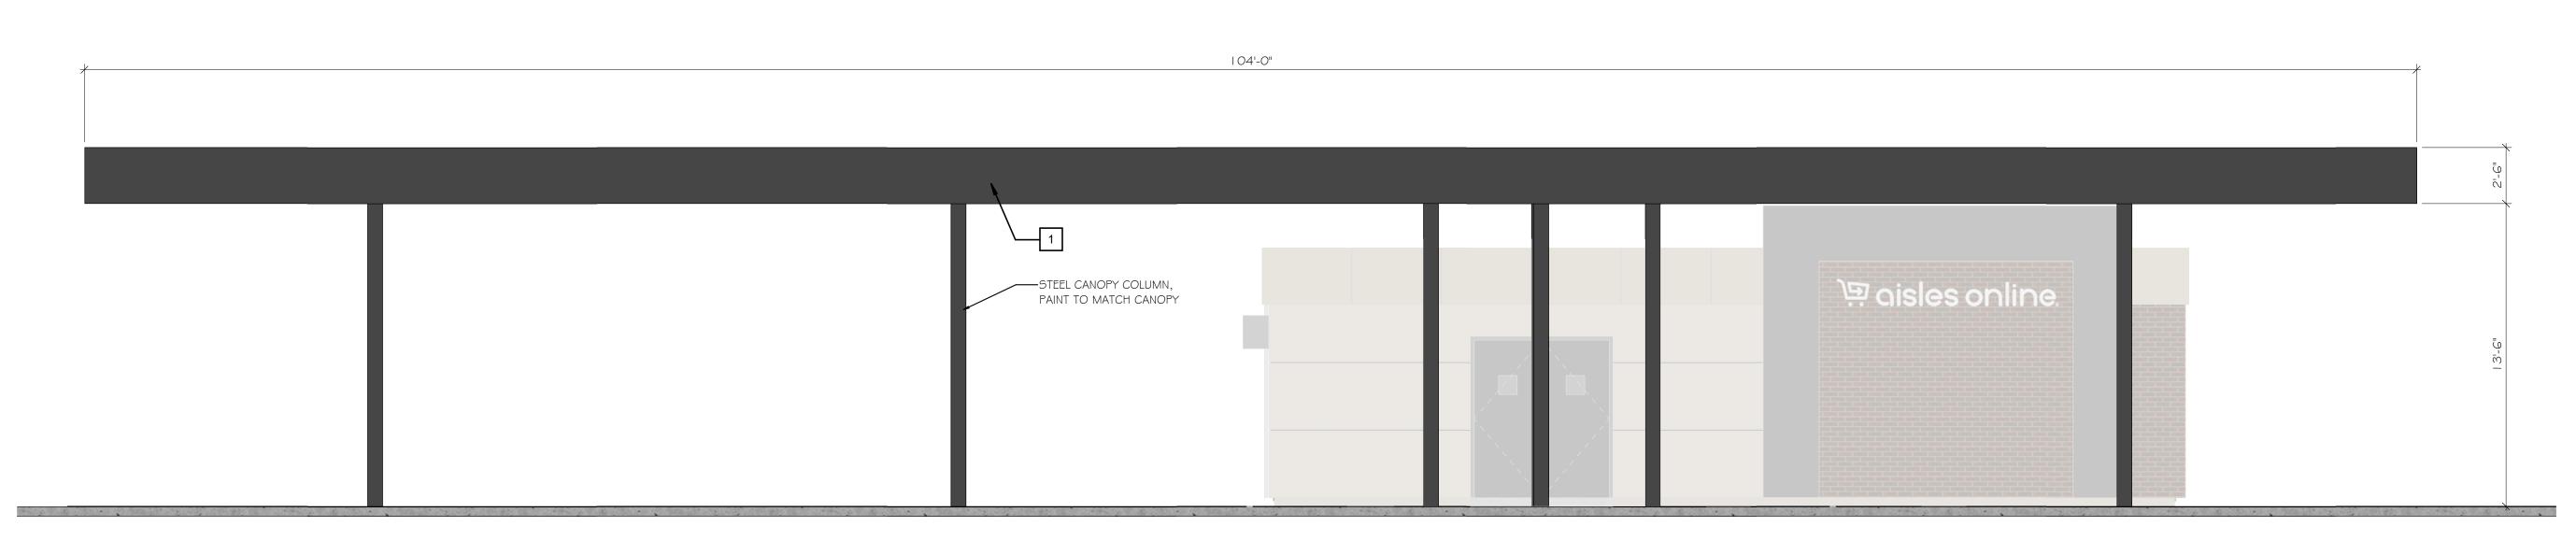


**MASONRY UNITS:** THIN BRICK BY KANSAS BRICK & TILE.
COLOR: #530 FLASH
SIZE: MODULAR
BOND: 1/3 RUNNING
MORTAR: SOLOMON GRIND 10H **CLADDING & CANOPIES:** HORIZONTAL CLADDING: STONEWOOD
COLOR: MATCH SHERWIN-WILLIAMS "MAISON BLANCHE" 7526 HORIZONTAL CLADDING: STONEWOOD COLOR: MATCH SHERWIN-WILLIAMS "NANTUCKET DUNE" 7527 HORIZONTAL CLADDING: STONEWOOD COLOR: "GRANITE GREY" 7026-CD **METAL TRIM COLORS:** PREFINISHED 0.40 ALUMINUM PANELS COLOR: MATCH STONEWOOD "GRANITE GRAY"

3 CANOPY ELEVATION


SCALE: 1/4" = 1'-0"



REVISION

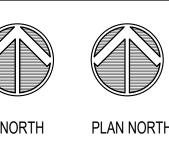

EXTERIOR ELEVATIONS

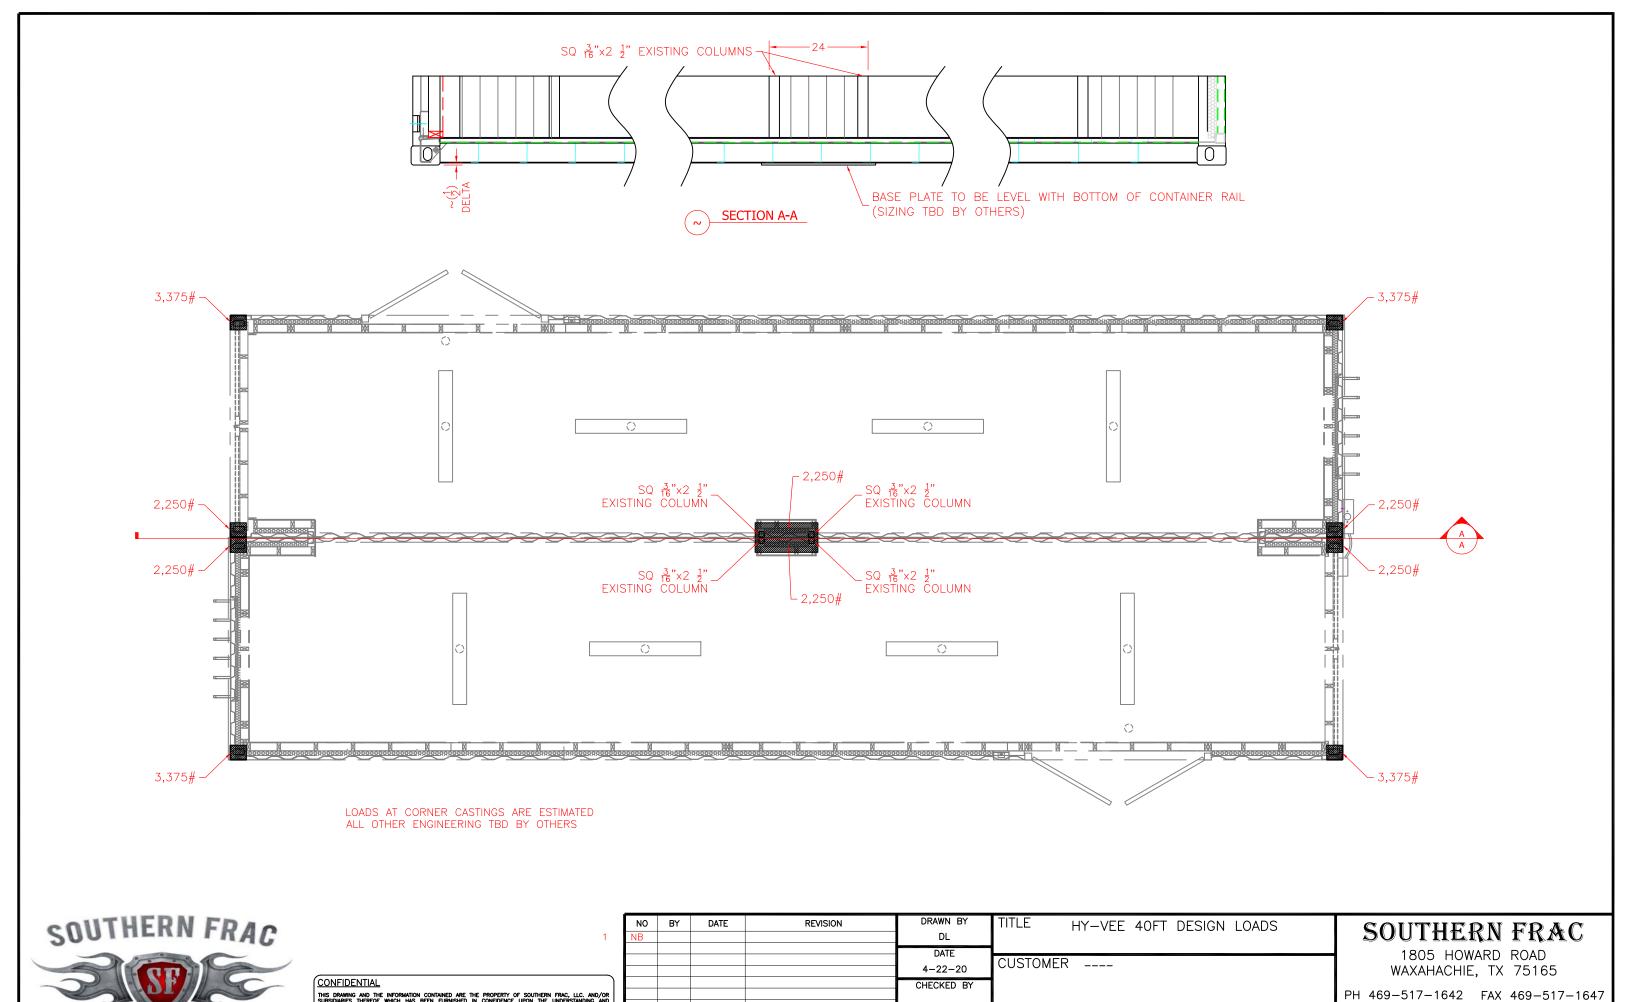

TANK MANUFACTURING

PURCHASE ORDER NO.

SCALE

N.T.S.

DATE

DRAWING NO.

HV40HCAO-EE-LOADS

### FLOOR:

EXISTING: 1 1/8" MARINE GRADE PLYWOOD DECKING: OEM OEM FLOOR COATED WITH EPOXY INSULATION: R-17 CLOSED CELL SPRAY INSULATION WITH ELASTOMERIC FINISH COAT

### INTERIOR WALLS:

FRAMING: 4" INSULATED WALL STRUCTURE WALL HEIGHT: 7'-6" MINIMUM INSULATION: R-25


### CEILING:

FRAMING: 4" INSULATED CEILING STRUCTURE CEILING HEIGHT: 7'-6" MINIMUM INSULATION: R-38

USED CONTAINER CRITERIA ALL REFURBISHED CONTAINERS ISO CERTIFIED, CARGO WORTHY CONDITION BEFORE ALTERATION. RECORDS OF CONTAINER HISTORY TO BE LOGGED PER QCM

### NOTES:

- SERIAL NUMBER STAMPED PLATE RIVETED TO DOOR
- ATTACH WALL SECTION TO FLOOR USING #8x1 5/8" LONG COARSE COARSE DRYWALL SCREWS
- ATTACH CEILING SUB-ASSEMBLY TO WALLS USING #8x 1 1/8" LONG COARSE THREAD DRYWALL SCREW
- SECURE WALL SECTION TO STEEL TUBE WINDOW AND MECHANICAL UNIT FRAME WITH 3" #12 HEX HEAD, SELF TAPPING SCREWS, MIN. OF 4 PER SIDE
- INSPECTION: 3RD PARTY, ICBO CERTIFIED DUE TO THE EXTREME WEIGHT FOR THE CONTAINER THERE ARE NO TIE DOWN REQUIREMENTS FOR THIS STRUCTURE.
- THE BUILDING IS DESIGNED AS AN INDEPENDENT STRUCTURE AND IS TO HAVE FIRE SEPARATION DISTANCE FROM OTHER STRUCTURES AS REQUIRED BY CODE. GENERAL CONTRACTOR TO PROVIDE ADEQUATE FIRE SEPARATION IN ACCORDANCE TO APPLICABLE STATE AND LOCAL CODES AND REQUIREMENTS. ALL DOORS TO OPENABLE FROM THE INTERIOR SIDE WITHOUT THE USE OF A KEY OR ANY SPECIAL KNOWLEDGE.

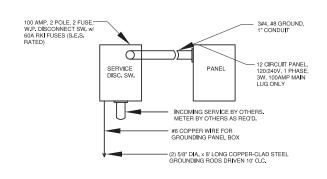

PANEL BOX CAN BE LOCATED ON EXTERIOR OR INTERIOR KEEPING A DIMENSION OF 36x36 CLEAR IN FRONT OF PANEL

> RST#16112 09/28/16

		-1	LOGNENTO								1
RESTROOM FACILITIES		3 NOTES	SCALE: N.T.S.	6 EL	ECTRICAL PANEL RI	ISER					SCALE: N.T.S.
A PLUMBING FACILITY, OWNED, OPERATED BY AND UN CONTROL OF THE SAME OWNERSHIP OF THIS STRUCT		CODES 2009 2012, 2015 IBC 2009 2012, 2015 IMC		DES	SIZE	TYPE		ROUGH OPEN	ING		
SHALL BE AVAILABLE AND THE MAX. TRAVEL DISTANC TO RESTROOM SHALL BE 500' OR PER LOCAL BLDG.	E	2009 2012, 2015 IPC		Α	36x84	STEEL/STEEL	JAMB	43 1/4" x	83 3/4"		
OFFICIAL.		2014 NEC 2012, 2015 IECC		В	80x101	DOOR STEEL/JA	MB STELL	EXISTING			
ACCESS TO BUILDING (STAIRS, RAMPS, ETC.) IS TO BE PROVIDED BY THE GENERAL CONTRACTOR IN		OCCUPANCY GROUP B		DOO	R TYPES (A)&(B) HA	RDWARE MUST CO	OMPLY w/ ICC//	ANSI A117.1-2003	SECTION 40	04.2.6	
ACCORDANCE WITH ADAAG.		CONSTRUCTION TYPE V-B OCCUPANCY LOAD 1		7 D0	OOR SCHEDULE						SCALE: N.T.S.
		ACCESSIBILITY ANSI/ICC A117.1	-2009	DES	SIZE	TYPE		ROUGH OPEN	ING	SILL HEI	SHT
1 BULDING CONSTRUCTION	SCALE: N.T.S.	4 CODES	SCALE: N.T.S.								
1. COVER PAGE		DESIGN LOADS LIVE FLOOR 125 PSF		1	30"x27"	ALUMINUM OF	VINYL	32" x 29"		36"	
2. FLOOR PLAN & ELEVATION		ROOF 55 PSF									
2. TEOORT LANGE ELEVATION		WIND (2009 IBC) 120 MPH, EXP C, 3 SEC WIND (2015 IBC) 155 MPH, EXP C, ULTIN		8 W	INDOW SCHEDULE						SCALE: N.T.S.
3. ELECTRICAL / MECHANICAL		SEISMIC DESIGN-CATEGORY D  SOIL BEARING 1.000 PSF	MATE	DES	SIZ	E	TY	PE	ROUGH OF	PENING	SILL HEIGHT
		7,000 1 01			34,130 BTU-H, 23,6	00 BTU-C	60HZ 230/2	208 EER 9.0	VERI	FY	N/A
2 DWG INDEX	SCALE: N.T.S.	5 DESIGN LOADS	SCALE: N.T.S.	9 H\	/AC 2TON WITH 10 K	W HEAT STRIP	777	ann),			SCALE: N.T.S.
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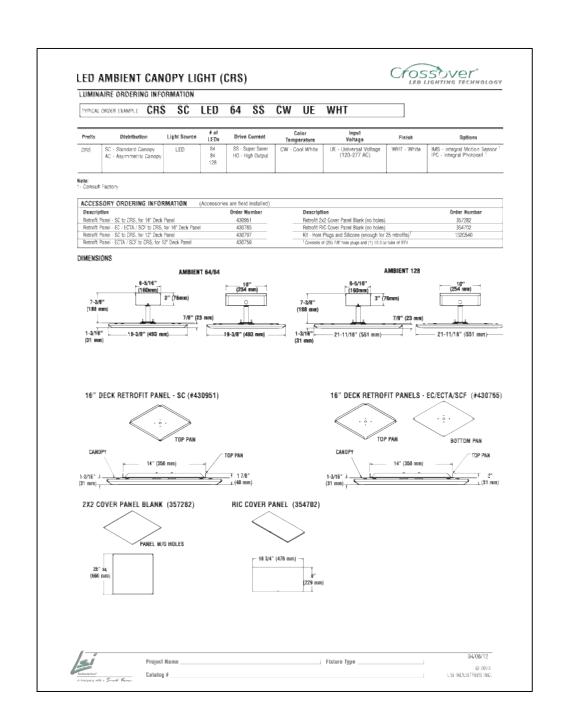
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				2016.09.19	CUSTOMER			WAXAHACH
				CHECKED BY	1			1
				RT				PH 469-517-1642
				DATE		SCALE	PURCHASE ORDER NO.	DRAWING NO.
				2016.09.19		N.T.S.		PV840AC


ERN FRAC HOWARD ROAD


WAXAHACHIE,	1.7	75165	
PH 469-517-1642	FAX 4	169-517-1647	








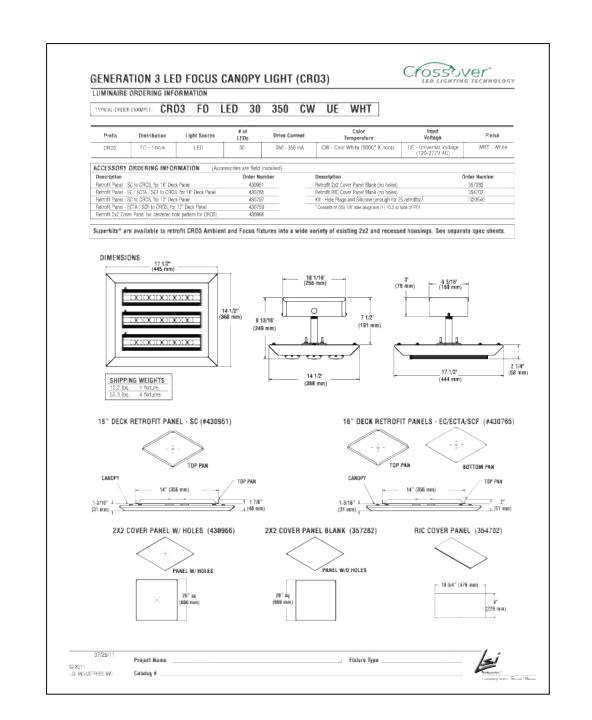

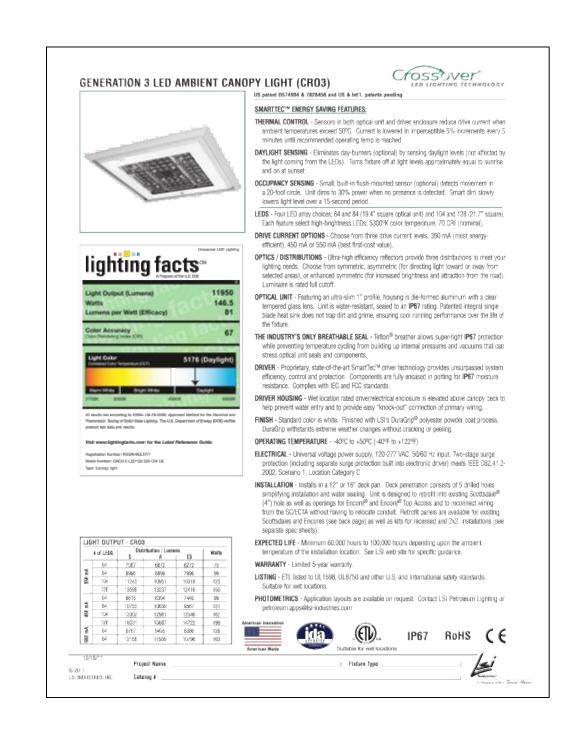

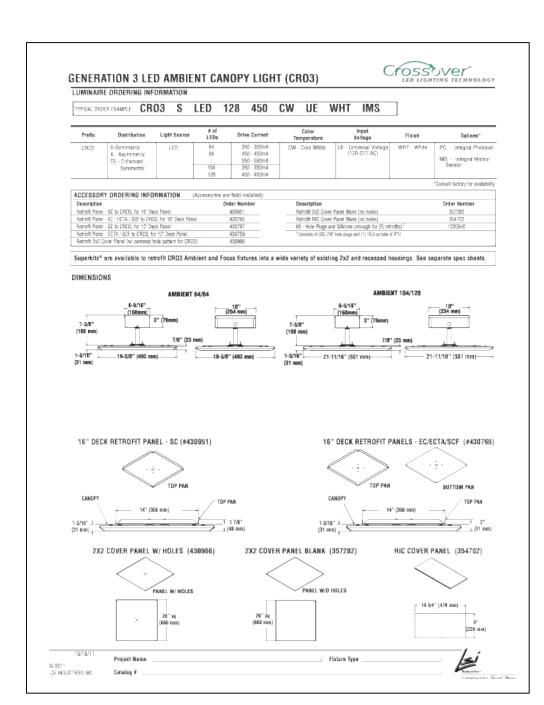



REVISION DATE: 05/14/2012

# Original Approvals

# SITE CONSTRUCTION DOCUMENTS FOR

# HY-VEE FITCHBURG #1

ORCHARD POINTE DEVELOPMENT 2920 FITCHRONA ROAD FITCHBURG, WI 53719 ORCHARD POINTE SUBDIVISION



# **OWNER / DEVELOPER**

HY-VEE, INC. 5820 WESTOWN PARKWAY WEST DES MOINES, IOWA 515-267-2800

# SITE MCKEE ROAD SITE NW 1/4 SECTION 7 T 6N, R 9E

# C1.0 EXISTING SITE AND DEMOLITION PLAN C2.0 SITE PLAN C3.0 GRADING AND EROSION PLAN C4.0 UTILITY PLAN C5.0 LANDSCAPING PLAN C6.0 LIGHTING PLAN C7.0 SITE DETAILS 1 C8.0 SITE DETAILS 2 C9.0 EROSION CONTROL AND RETAINING WALL DETAILS C10.0 SITE SECTIONS

# SITE CIVIL ENGINEER

SRF CONSULTING GROUP, INC.
901 DEMING WAY, SUITE 302
MADISON, WI 53717
608-831-4245

# **SURVEYOR**

CEDAR CORPORATION

1402 PANKRATZ ST., SUITE 320

MADISON, WI. 53704

608-354-0037

# **GEOTECHNICAL ENGINEER**

CGC, INC. 2921 PERRY STREET MADISON, WI 53713 608-288-4100

# **UTILITY CONTACTS**

GAS
MADISON GAS & ELECTRIC
PO BOX 1231
MADISON, WI 53701-1231
DON McCLAIN
608-252-5618

ELECTRIC
ALLIANT ENERGY
2147 CTH PB
VERONA, WI 53593
JEFF NELSON
608-845-1148

TELECOMMUNICATIONS

AT&T — WISCONSIN

316 WEST WASHINGTON AVE, 3rd FLOOR

MADISON, WI 53703

ANDY MADSEN (am4171@att.com)

608-252-2432



Hearing Impaired TDD (800) 542-2289

www.DiggersHotline.com

# REGULATORY AGENCIES

MAYOR: SHAWN PFAFF 608-270-4213

DEPARTMENT OF PLANNING & ZONING THOMAS HOVEL, ZONING ADMINISTRATOR, CITY PLANNER 608-270-4255

BUILDING INSPECTION UNIT: JOHN CROOK, BUILDING INSPECTOR 608-270-4240


CITY OF FITCHBURG PUBLIC WORKS
PAUL WOODARD, PUBLIC WORKS DIRECTOR, CITY ENGINEER
608-270-4260


FIRE CHIEF: RANDALL L. PICKERING 608-278-2965

POLICE CHIEF: THOMAS A. BLATTER 608-270-4351

CITY HALL 5520 LACY ROAD FITCHBURG, WI 53711 608-270-4260

PRELIMINARY
NOT FOR CONSTRUCTION

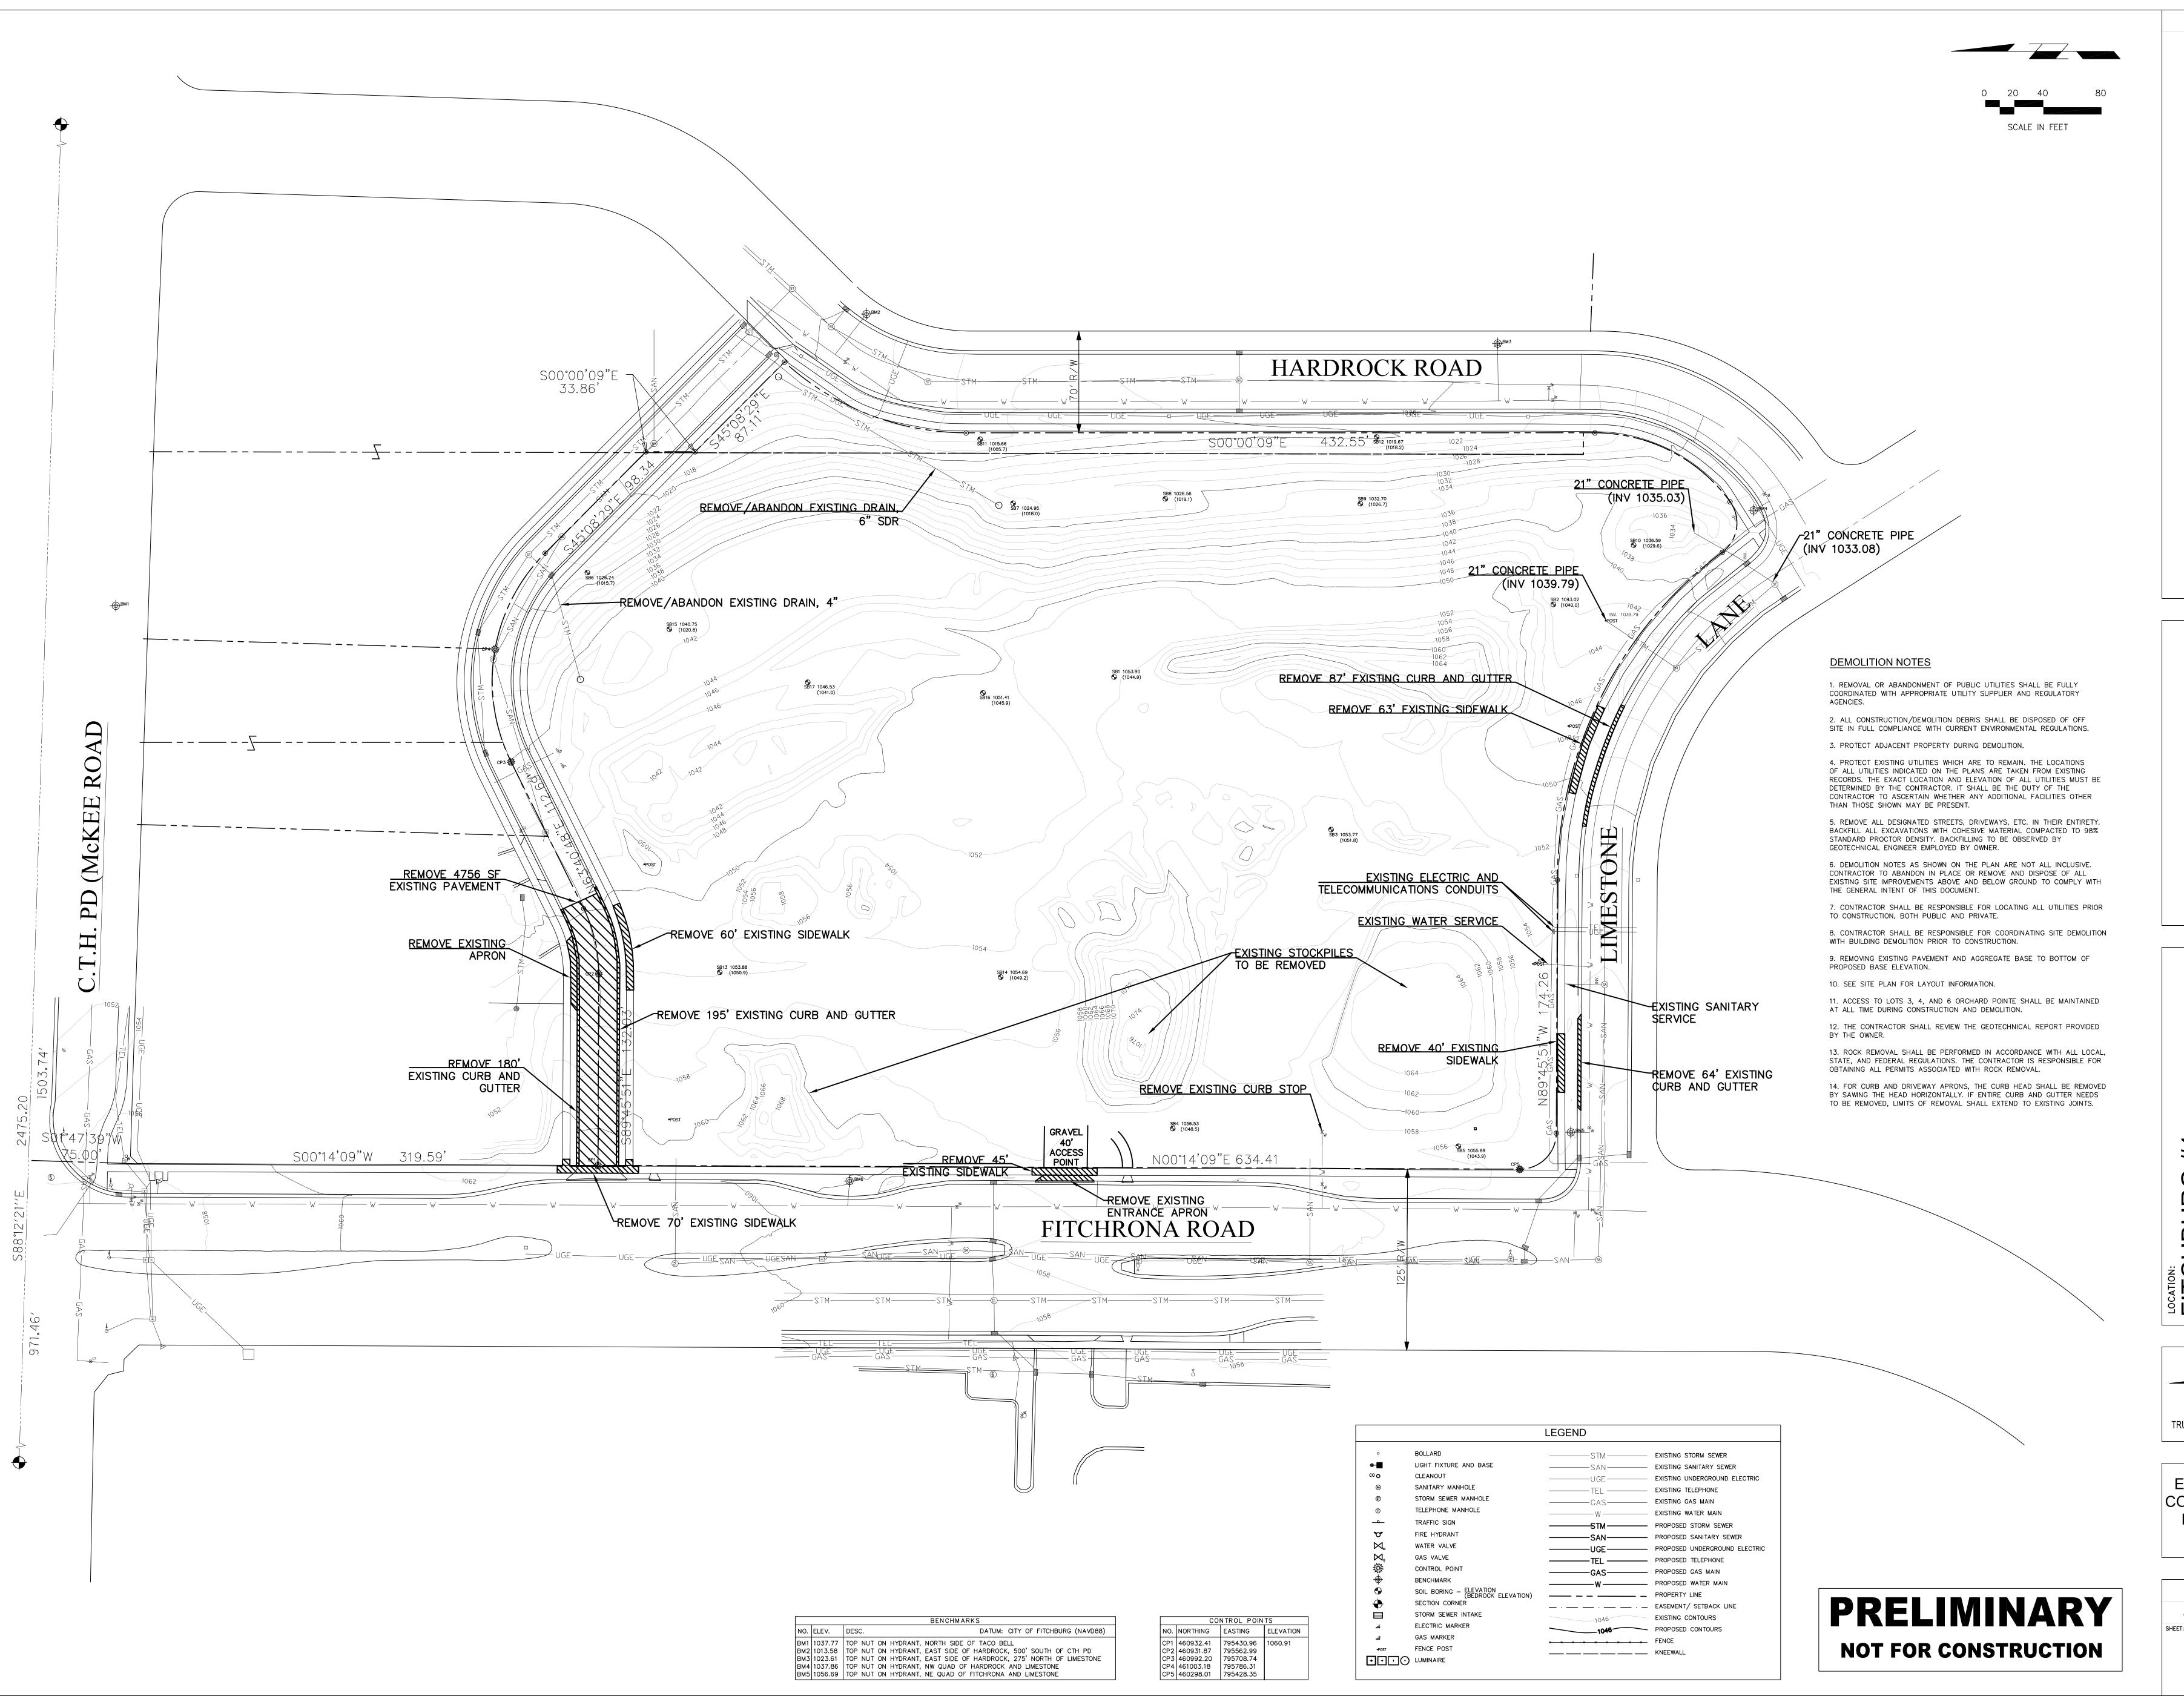

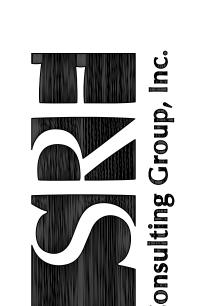

REVISION

FITCHBURG #1
ORCHARD POINTE


HY-VEE, INC.
5820 WEST DES MOINES, IOWA 50266
TELEPHONE: (515) 267-2800
FAX: (515) 267-2935


TRUE NORTH PLAN NORTH

EXISTING SITE CONDITIONS AND DEMOLITION PLAN

DRAWN: DATE:
RAB 2011
SCALE: JOB NUMBER:
1"=40' 7555
SHEET:

C1.0

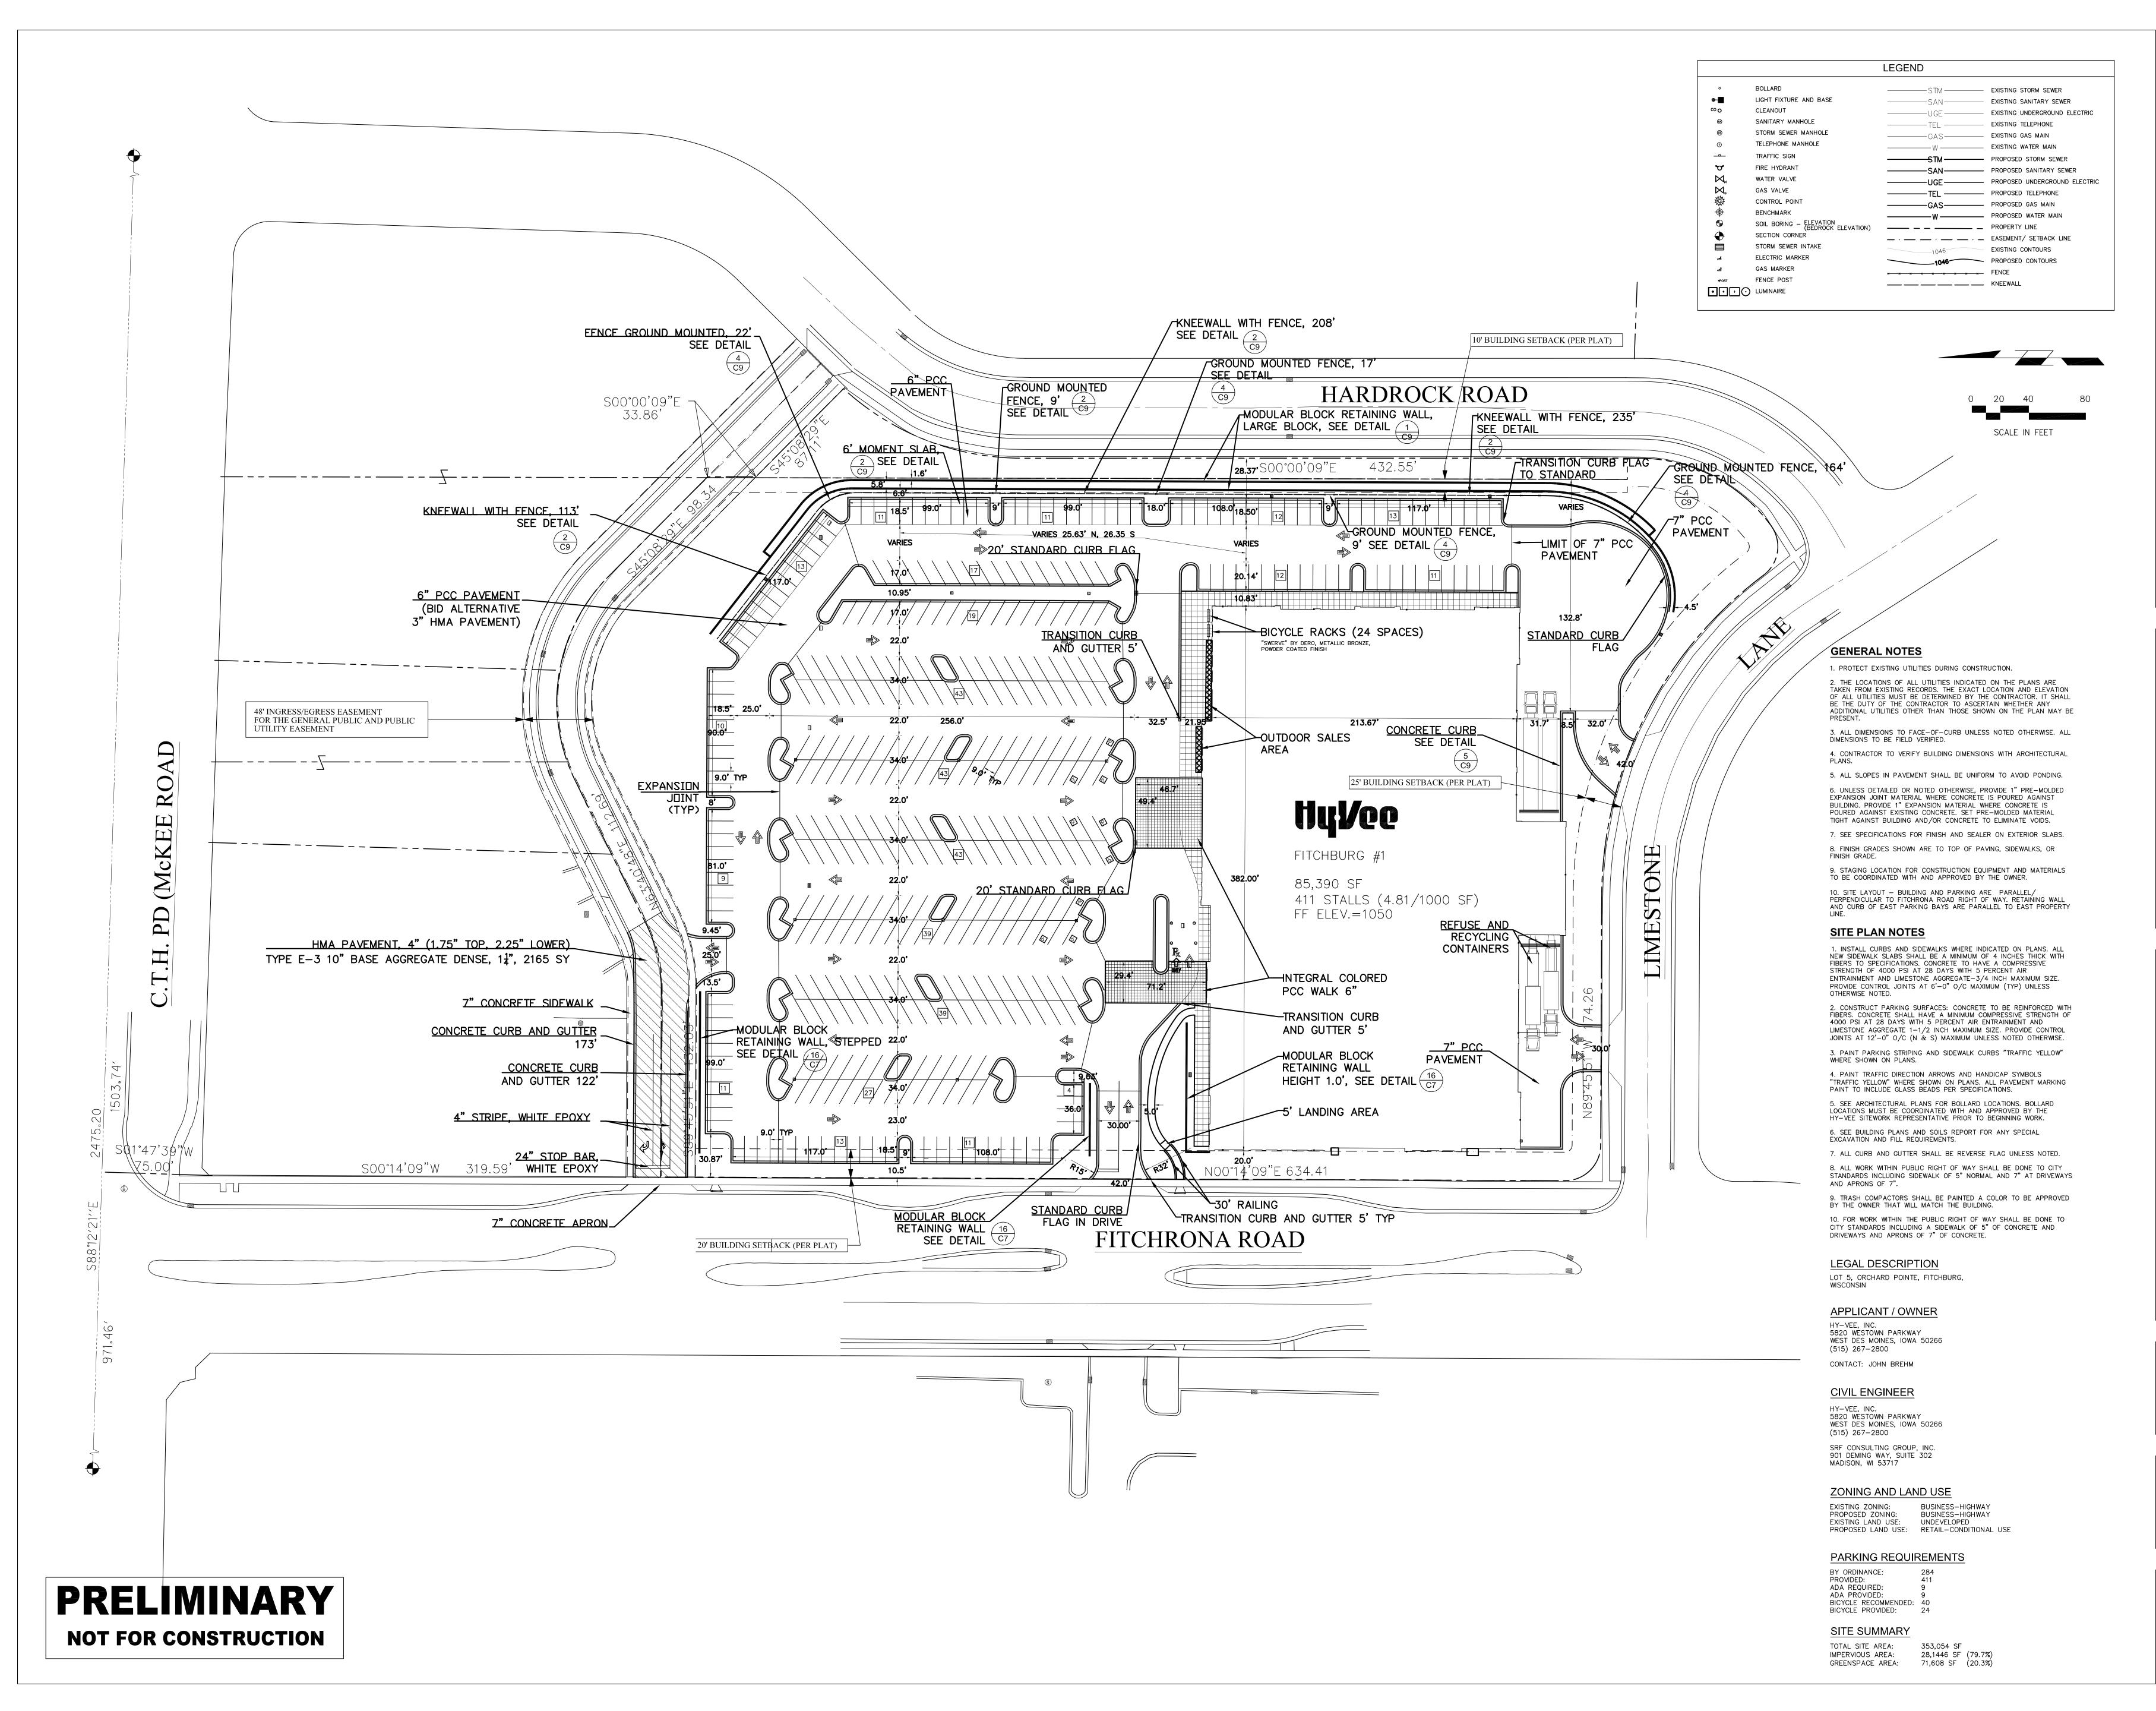

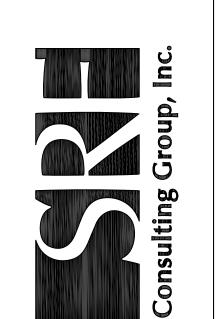

REVISION

FITCHBURG #1
ORCHARD POINTE

HY-VEE, INC.
5820 WESTOWN PARKWAY
WEST DES MOINES, IOWA 50266
TELEPHONE: (515) 267-2800
FAX: (515) 267-2935

TRUE NORTH PLAN NORTH

TRUE NORTH PLAN NORT


SITE PLAN

RAB 2012

SCALE: JOB NUMBER: 7555

EET:

C2.0

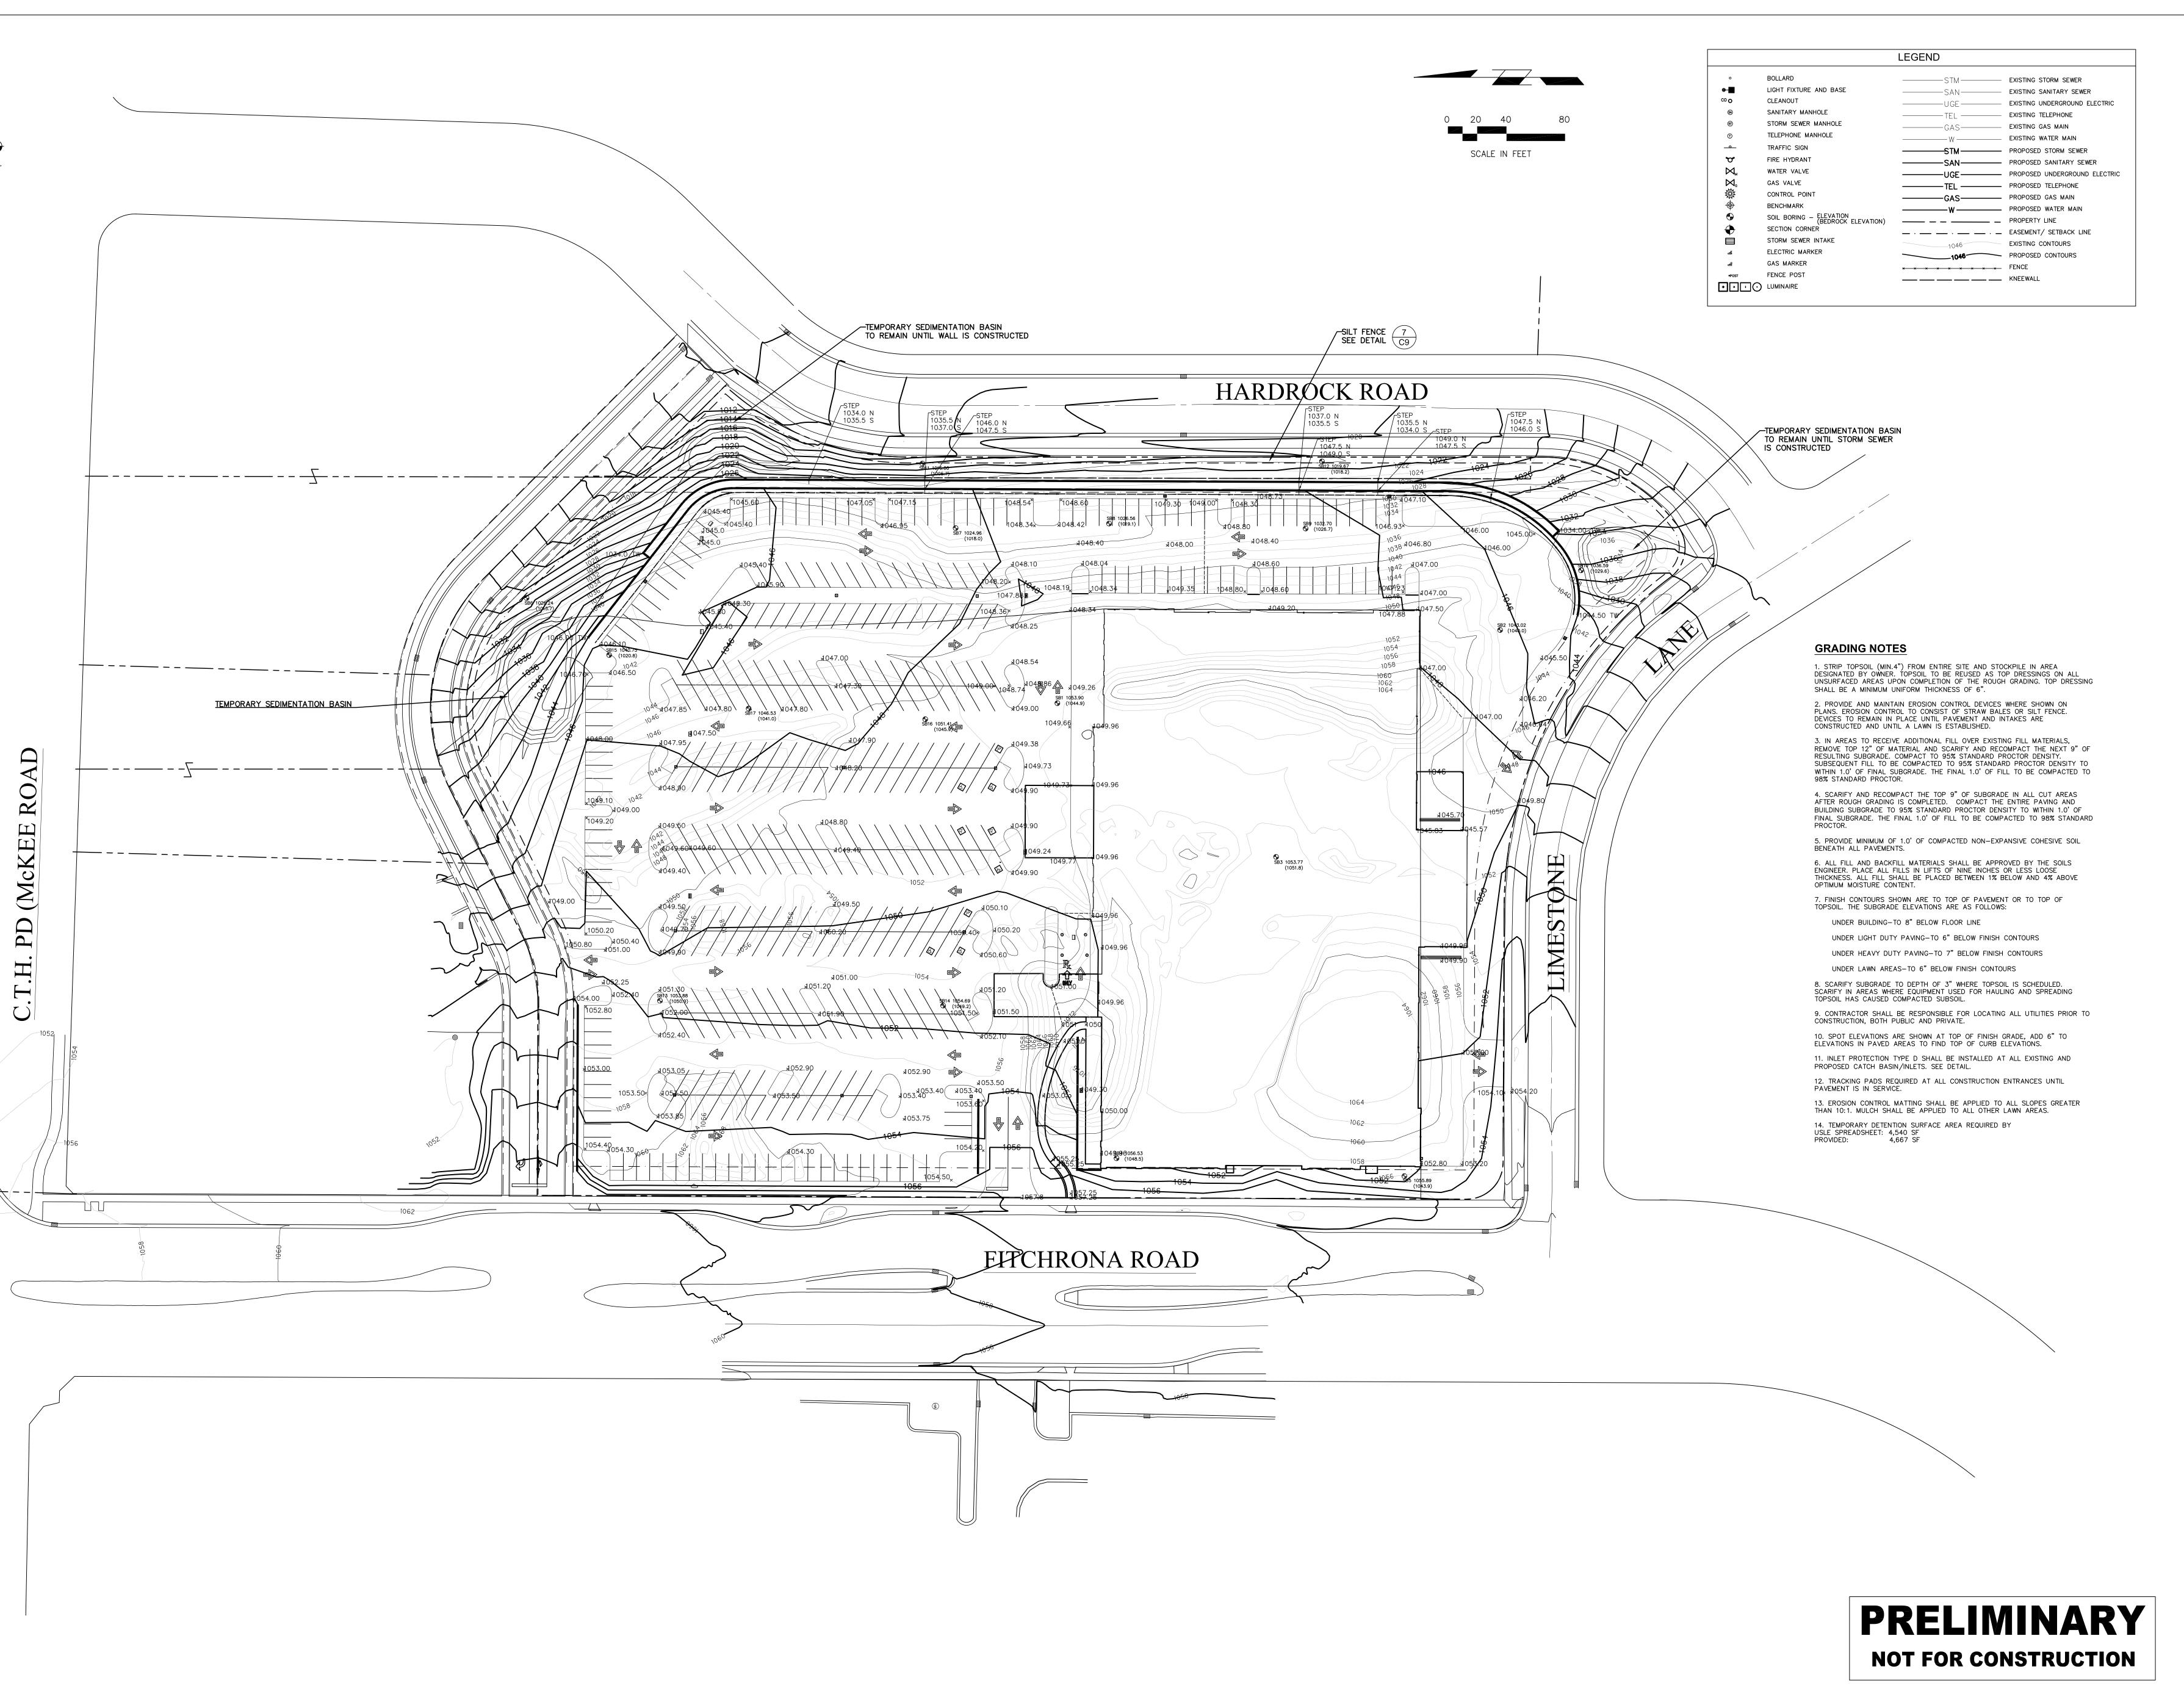



REVISION

FITCHBURG #1

ORCHARD POINTE

HY-VEE, INC.
5820 WEST DES MOINES, IOWA 50
WEST DES MOINES, IOWA 50
TELEPHONE: (515) 267-2835
FAX: (515) 267-2935

TRUE NORTH PLAN NORTH

GRADING AND EROSION PLAN

DRAWN: DATE:


RAB 2011

SCALE: JOB NUMBER:

1"=40' 7555

SHEET:

C3.0

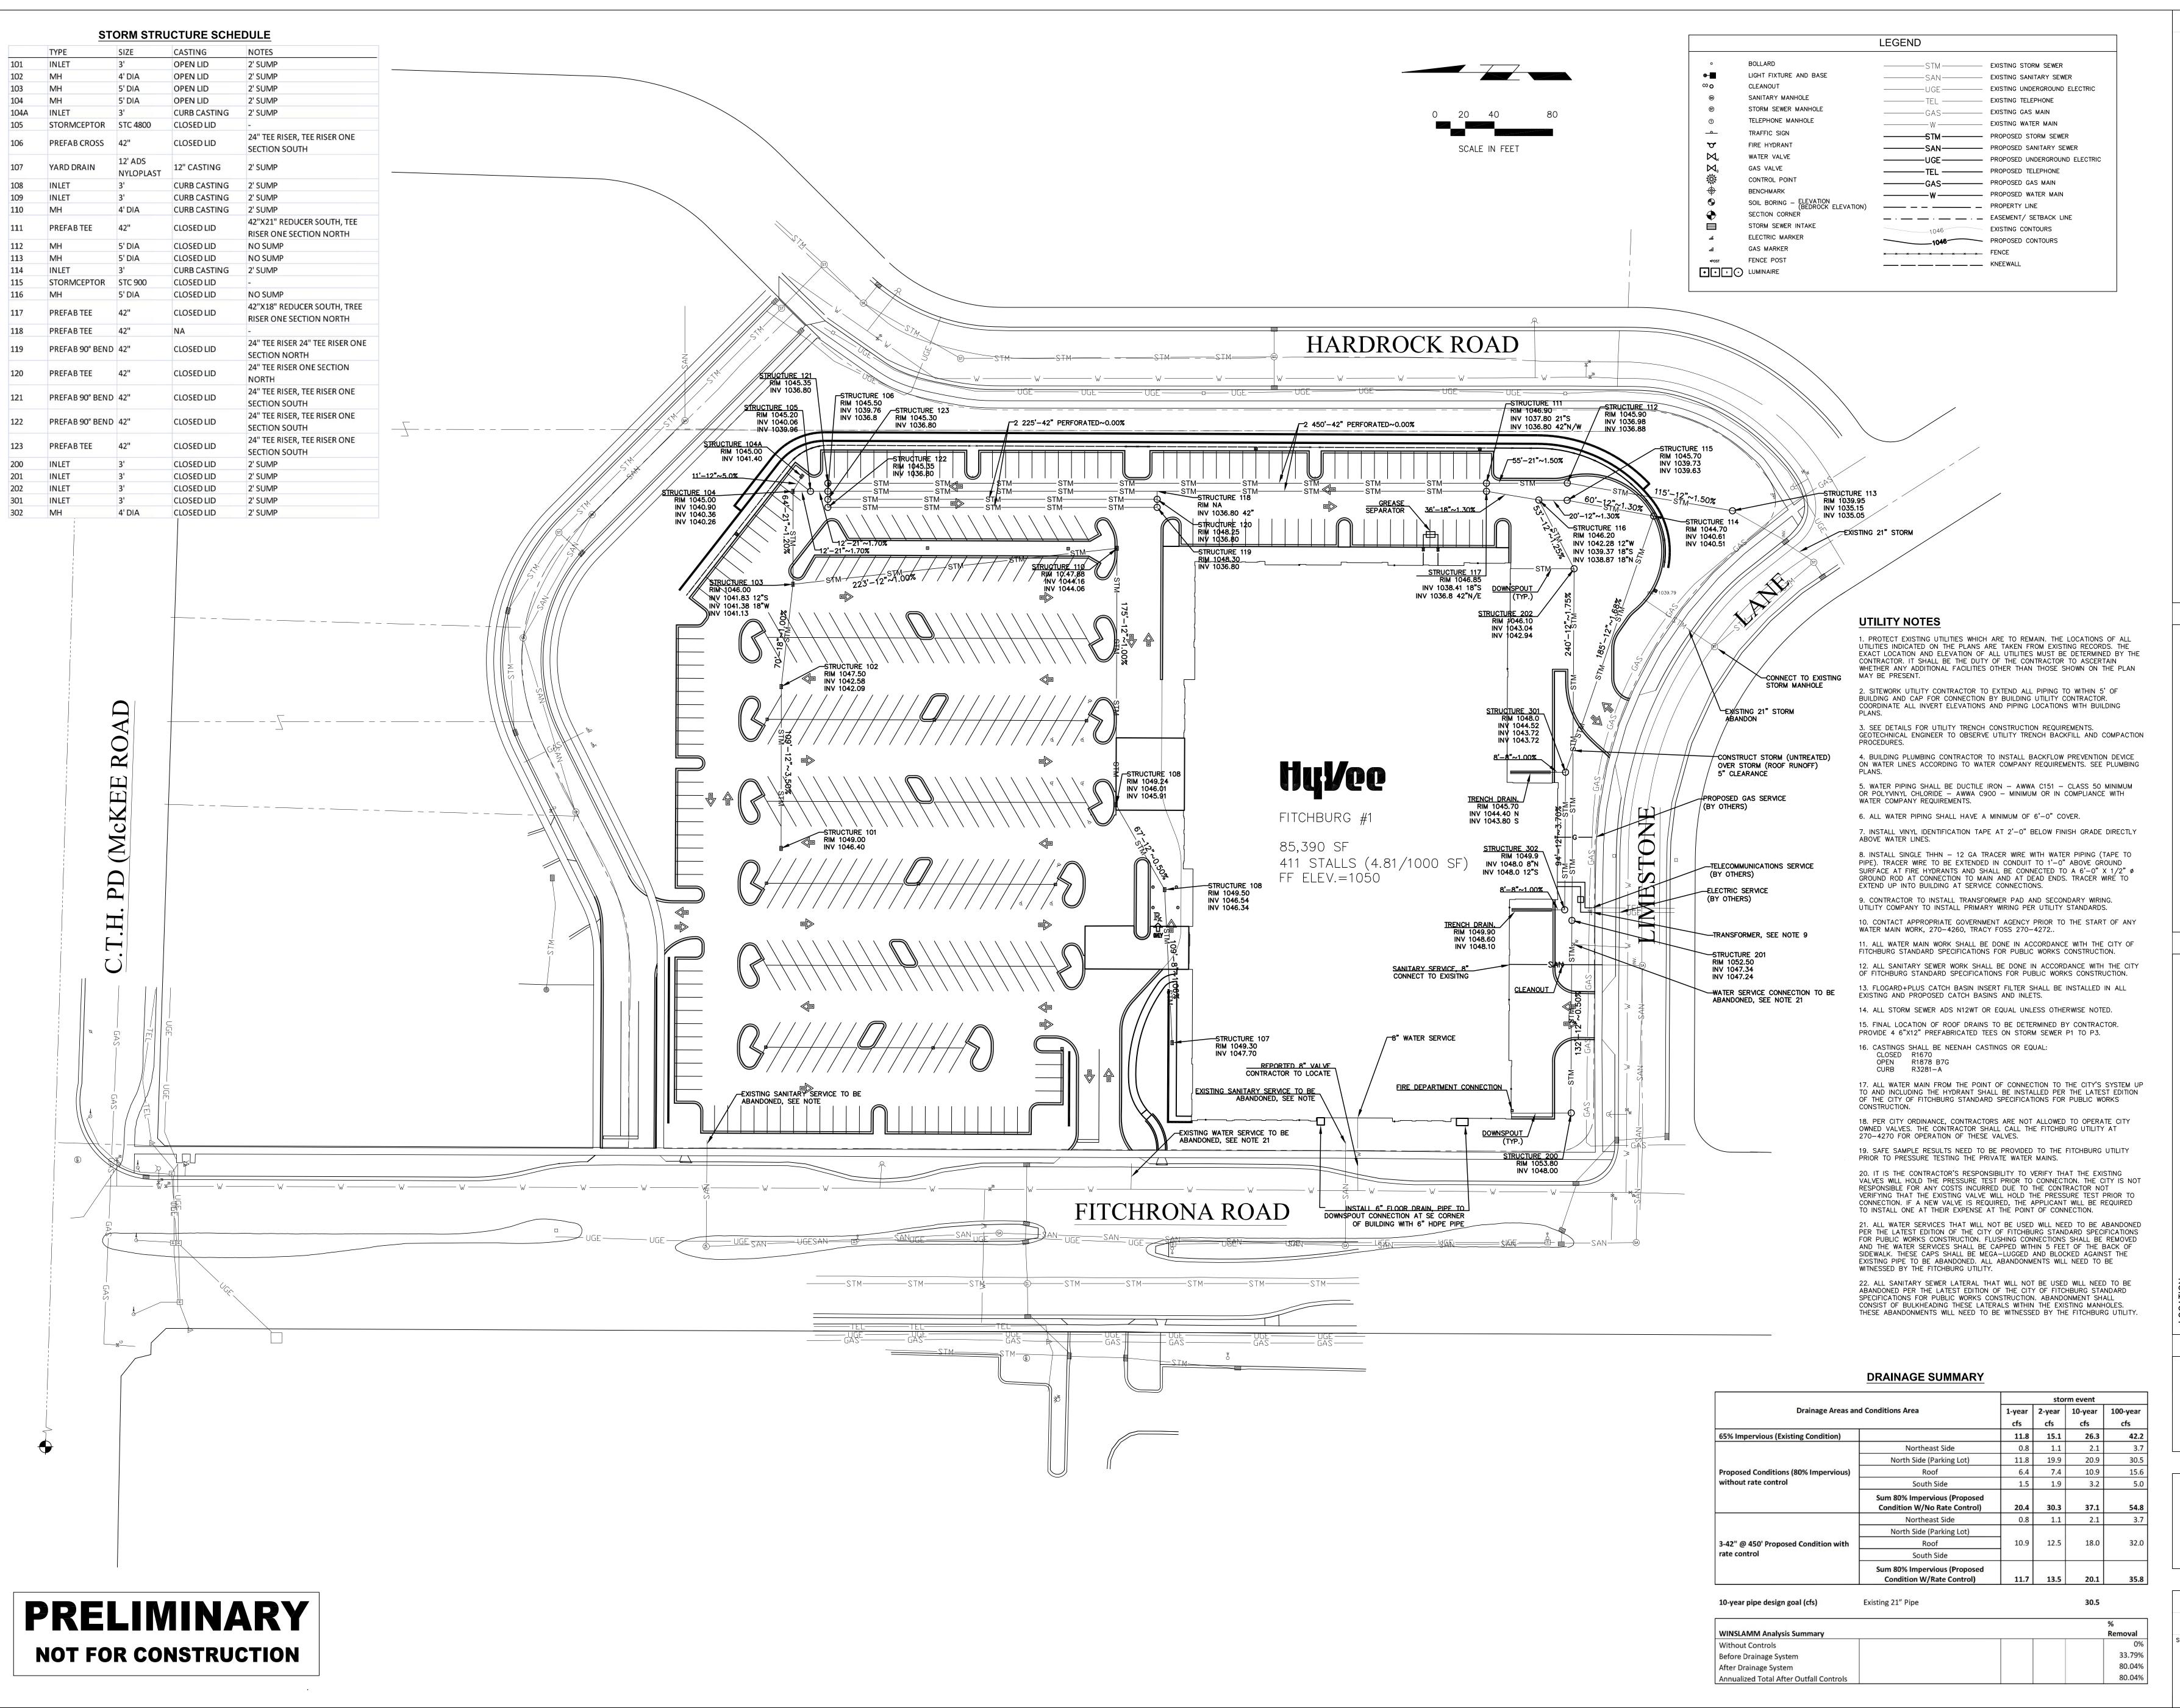

Group, Inc.

REVISION


FITCHBURG #1
ORCHARD POINTE
HY-VEE, INC.
5820 WESTOWN PARKWAY
WEST DES MOINES, IOWA 5026
TELEPHONE: (515) 267-2830
FAX: (515) 267-2935


- -

TRUE NORTH PLAN NORTH

UTILITY PLAN

DRAWN: DATE:
RAB 2011
SCALE: JOB NUMBER:
1"=40' 7555
EET:

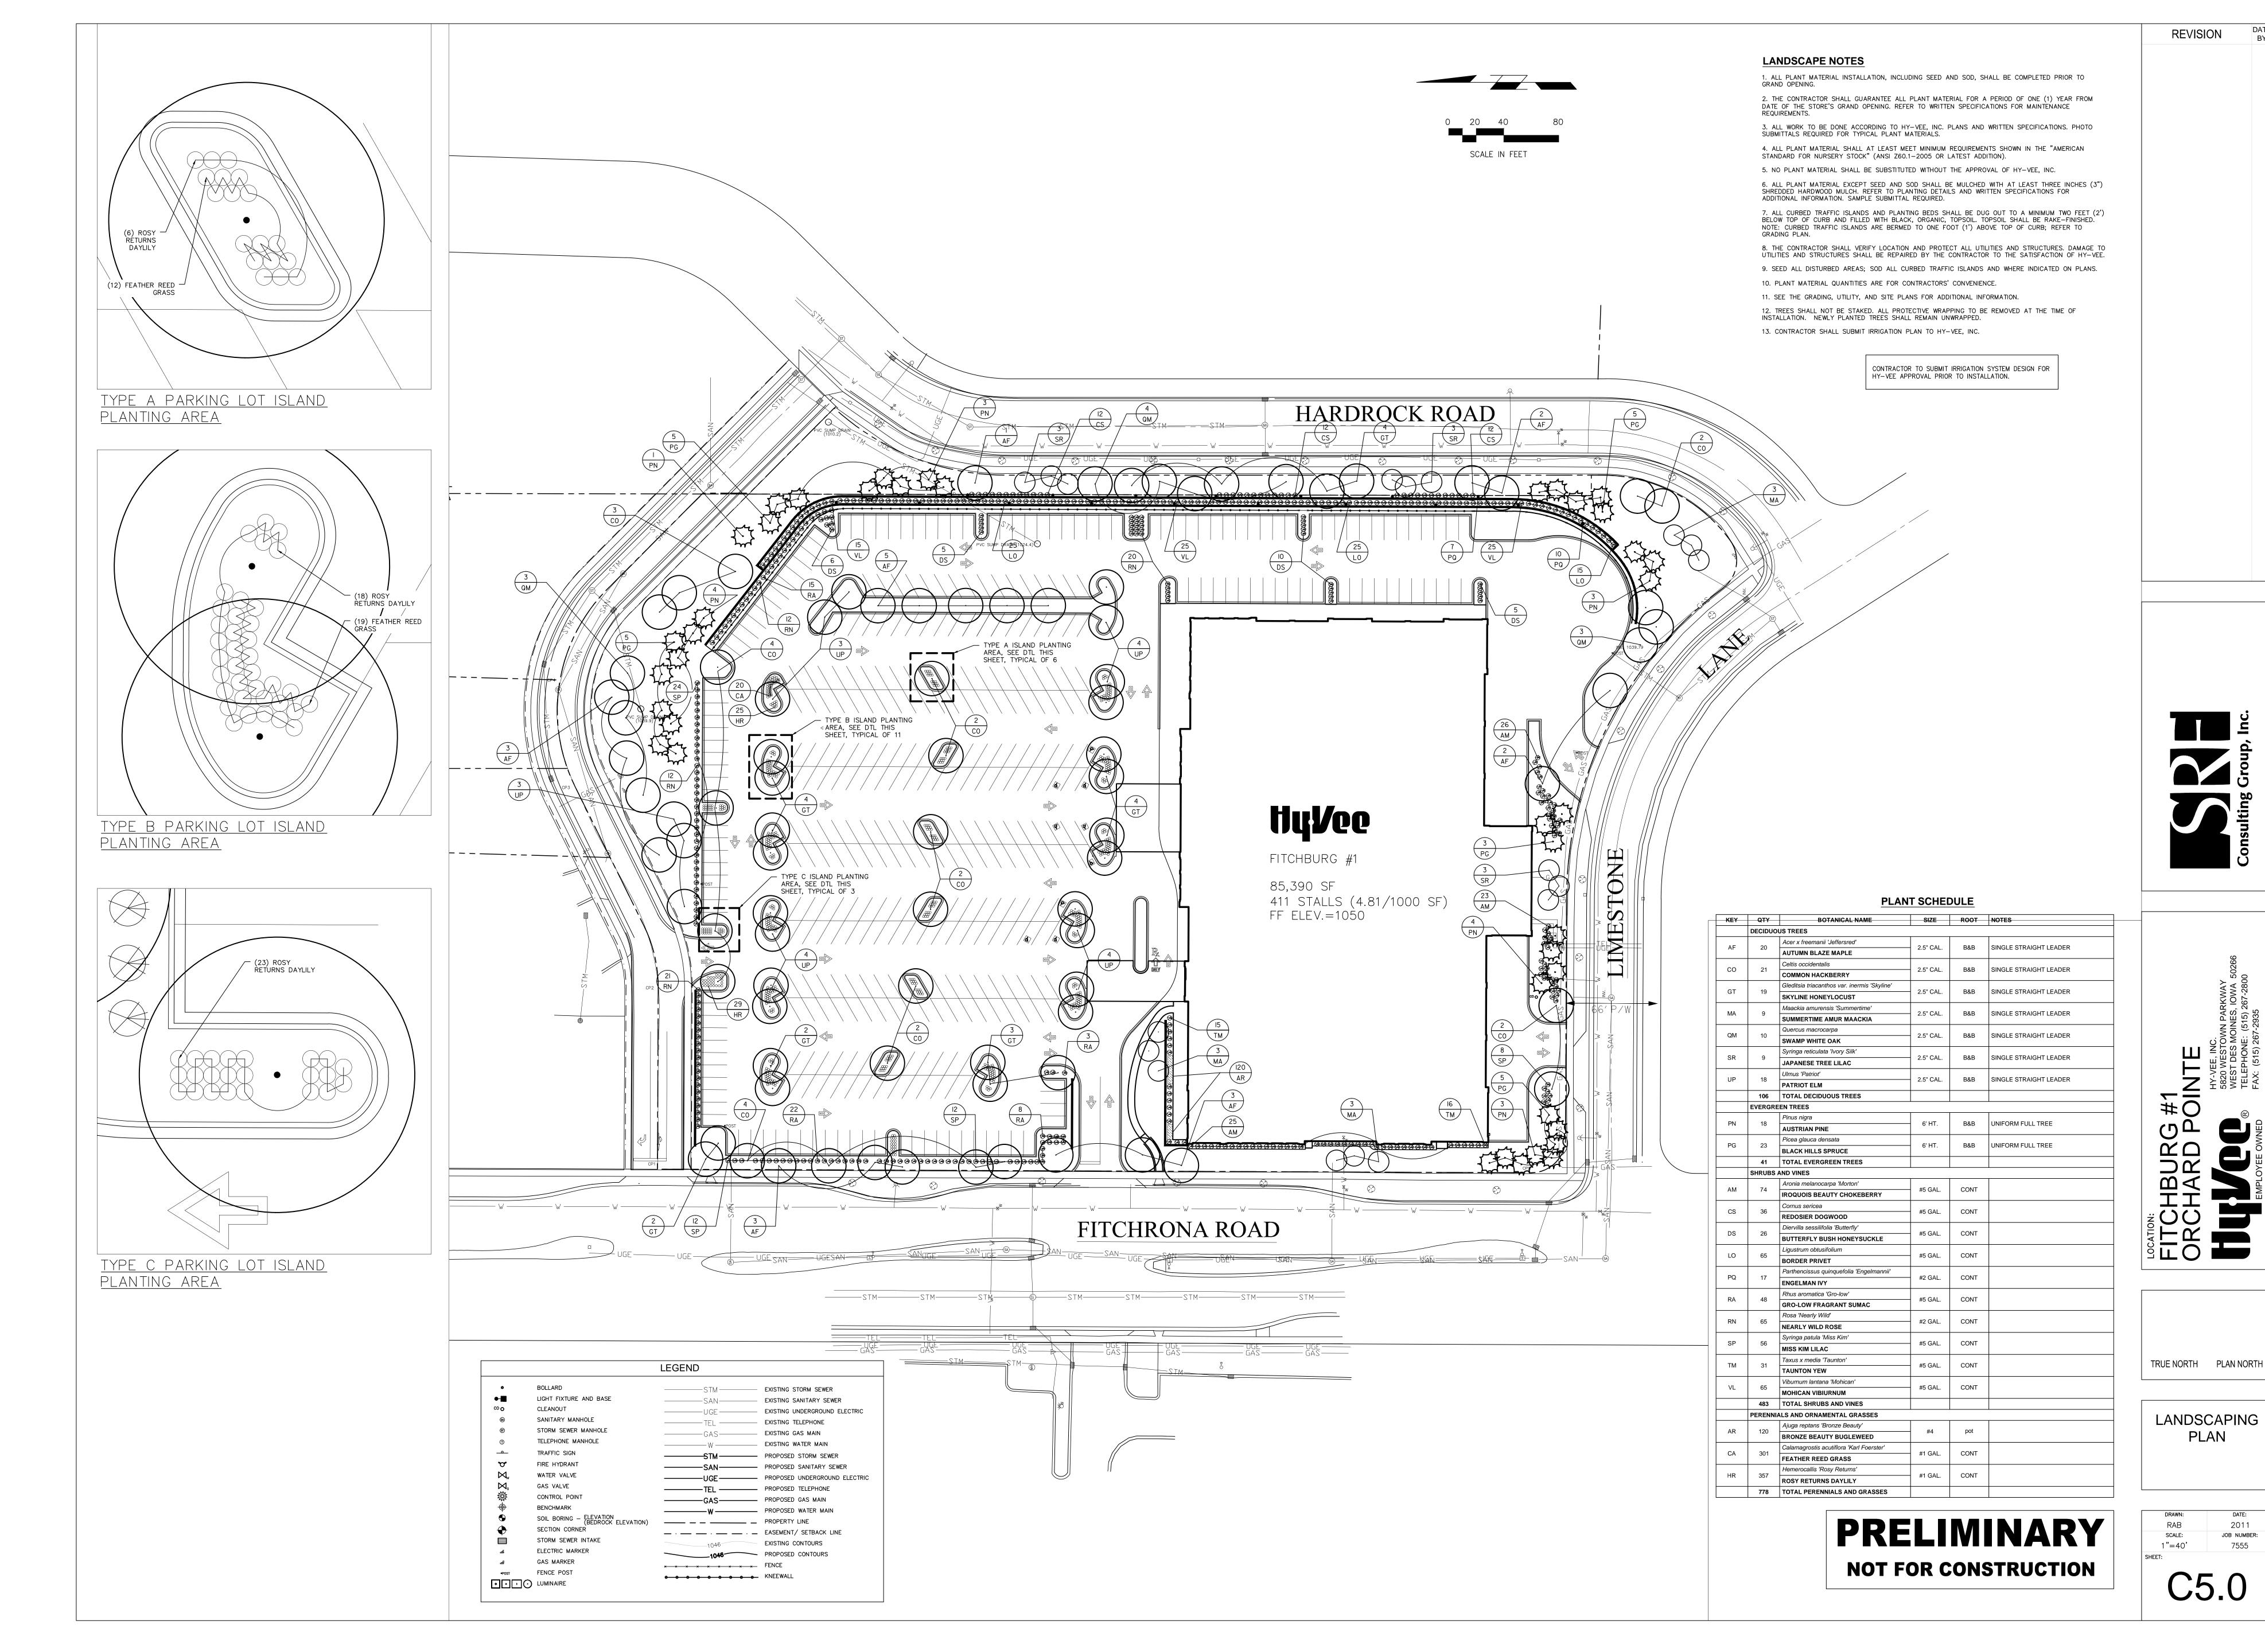

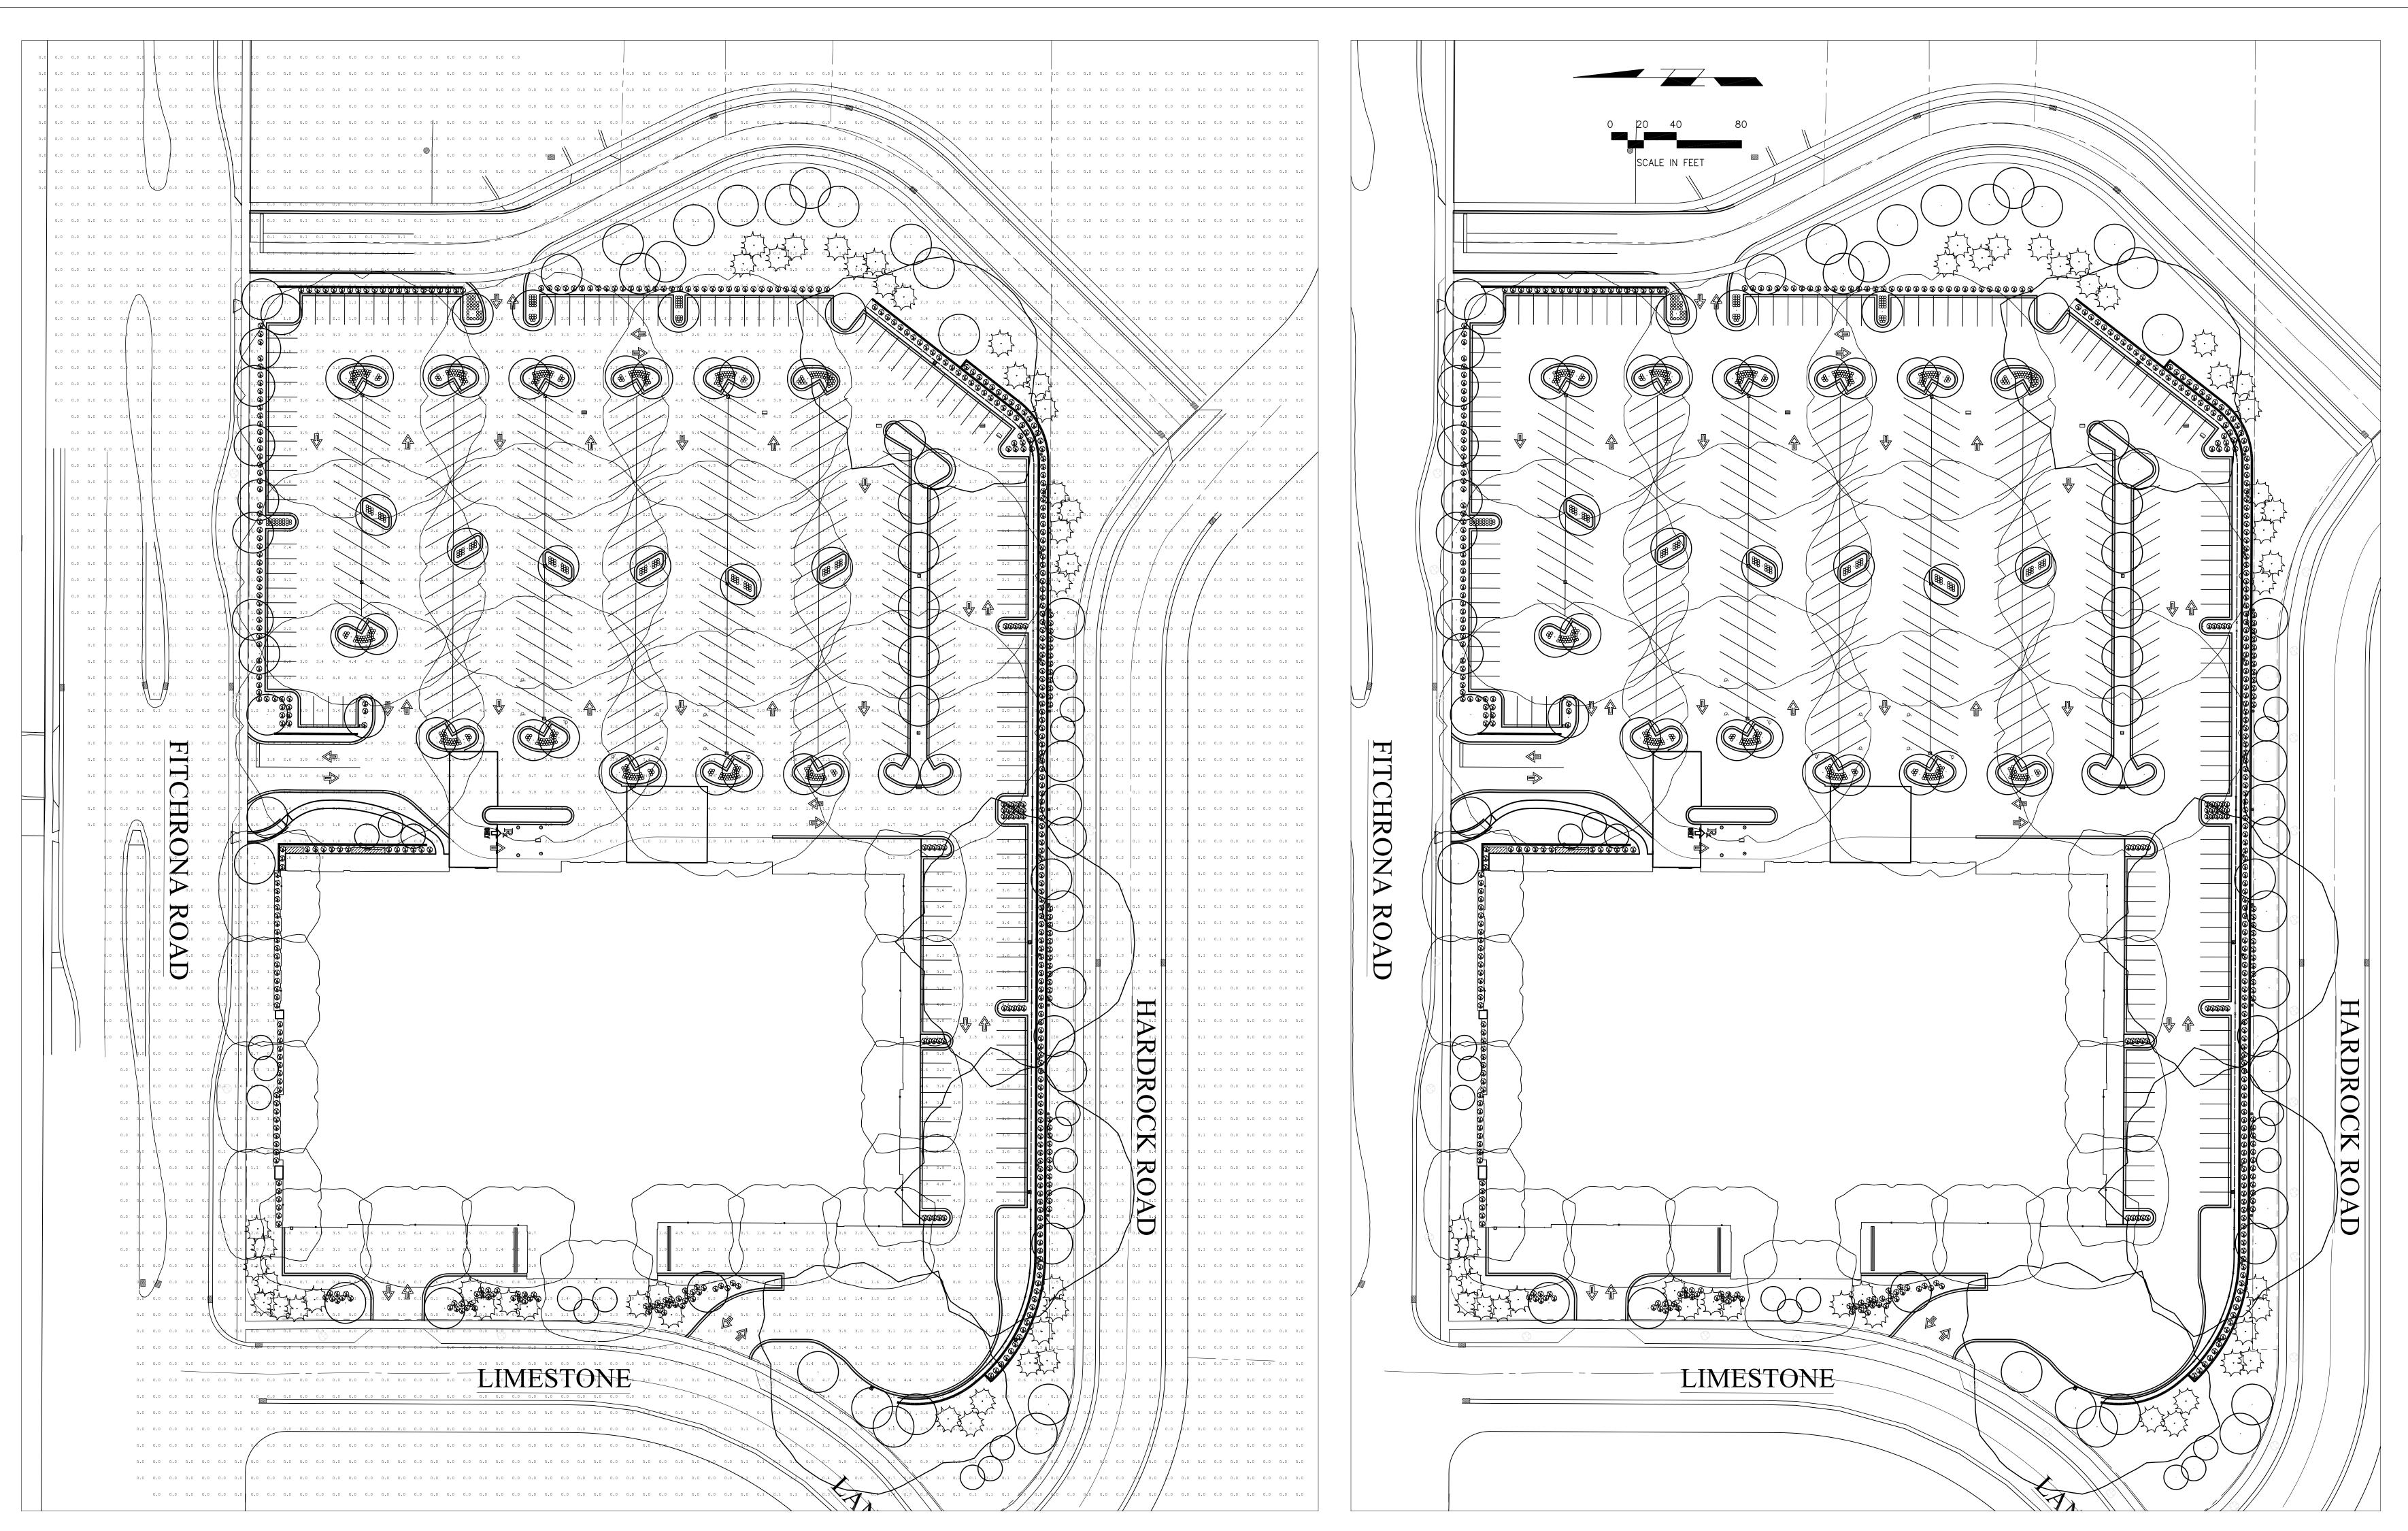



THE LACK OF DAMAGE.

HY-VEE STONE MOUNTED LIGHTING.

LEGEND

-----STM ----- EXISTING STORM SEWER

TEL EXISTING TELEPHONE

\_\_\_\_\_W \_\_\_\_EXISTING WATER MAIN

1046 EXISTING CONTOUR

1046 PROPOSED CONTOUR

——— — PROPERTY LINE

\* \* \* \* \* \* \* \* FENCE

\_\_\_\_ \_\_ \_\_ KNEEWALL

\_\_ · \_\_ \_ · \_\_ EASEMENT/ SETBACK LINE

-----GAS-EXISTING GAS MAIN

-----UGE ----- EXISTING UNDERGROUND ELECTRIC

BOLLARD

CLEANOUT

TRAFFIC SIGN

FIRE HYDRANT

WATER VALVE

GAS VALVE

BENCHMARK

CONTROL POINT

SECTION CORNER

ELECTRIC MARKER

GAS MARKER

FENCE POST

◆ → → O LUMINAIRE

STORM SEWER INTAKE

SOIL BORING — ELEVATION (BEDROCK ELEVATION)

LIGHT FIXTURE AND BASE

SANITARY MANHOLE

STORM SEWER MANHOLE

TELEPHONE MANHOLE

•

 $\bowtie_{\!\scriptscriptstyle{\mathsf{W}}}$ 

1. NOTIFICATION: CONTRACTOR SHALL NOTIFY HY-VEE (FAX: 515-267-2935) A MINIMUM OF 60 DAYS PRIOR TO THE ANTICIPATED DATE OF INSTALLATION.

2. MATERIAL: OWNER WILL PURCHASE SITE LIGHTING MATERIALS. THOSE MATERIALS INCLUDE THE FOLLOWING: FIXTURES WITH LAMPS, TENON, POLE, ANCHOR BOLTS AND ANCHOR BOLT TEMPLATE. THE GENERAL CONTRACTOR IS RESPONSIBLE FOR RECEIVING, UNLOADING, AND VERIFYING QUANTITIES AND CONDITIONS OF THESE MATERIALS. INSPECT ALL PACKAGES FOR EXTERIOR DAMAGE BEFORE THE CARRIER LEAVES THE SITE, AND NOTIFY EITHER HY-VEE/WEITZ OR OWNER'S REPRESENTATIVE WITH INFORMATION ON THE SHIPMENT. RETURN A COPY OF THE PACKING LIST TO HY-VEE WITHIN SEVEN DAYS AFTER RECEIPT OF THE MATERIALS WITH NOTES REGARDING ANY DAMAGED GOODS OR

3. STORAGE OF MATERIALS: THE CONTRACTOR SHALL BE RESPONSIBLE FOR STORAGE AND PROTECTION OF ALL SITE LIGHTING MATERIALS, AND FOR INSTALLATION OF A FUNCTIONING SYSTEM WHICH MEETS HY—VEE'S APPROVAL. NIGHT TIME ADJUSTMENT OF FLOODLIGHTS IS REQUIRED. THE CONTRACTOR SHALL PROVIDE A ONE—YEAR (1) WARRANTY ON HIS LABOR FOR THE WORK.

WARRANTY ON HIS LABOR FOR THE WORK.

4. CONDUIT AND WIRE: CONDUIT AND WIRE FOR SITE LIGHTING SHALL BE
BY THE GENERAL CONTRACTOR AND APPROVED BY HY-VEE.

5. TESTING: A MINIMUM OF 30 DAYS BEFORE THE STORE'S GRAND OPENING, THE CONTRACTOR SHALL CONDUCT A 100 HOUR CONSECUTIVE TEST OF THE SITE LIGHTING SYSTEM. THIS IS INTENDED TO EXPOSE BURNED OUT LAMPS OR OTHER PROBLEMS WHILE ELECTRICIANS AND EQUIPMENT ARE STILL ON SITE. HY—VEE SHALL BE NOTIFIED WITH THE RESULTS OF THIS TEST AS SOON AS POSSIBLE SO REPLACEMENT MATERIALS CAN BE OBTAINED IF NECESSARY.

6. WRING INFORMATION: SEE SHEET E-1 FOR CIRCUIT AND PANEL ASSIGNMENTS.
A WRING DIAGRAM FOR THE PARKING LOT LIGHTS IS REQUIRED FOR FUTURE
REFERENCE. MAKE EDITS ON SITE UTILITY PLAN AND RETURN TO OWNER WITH AS-BUILT
NOTES.

7. REFER TO FIXTURE AND POLE BASE DETAIL.

8. ALL LIGHTING MUST BE DOWN CAST. HY-VEE GAS CANOPY MUST HAVE FINISH

SYMBOL	QTY	LABEL	ARRANGEMENT	TOTAL LAMP LUMENS	LLF	DESCRIPTION
•	4	P2	SINGLE	82000	0.750	AL4P-750-3F-XXX-25' POLE ON 3' BASE
•	11	P1	SINGLE	82000	0.750	AL4P-750-5F-XXX - 25' POLE ON 3' BASE
•	15	W	SINGLE	12500	0.750	WTM150MMT-FWT
$\odot$	4	CL	SINGLE	20500	0.750	RDS250M-SFS138C (C)

PARKING LOT

Illuminance (Fc)
Average = 3.42


Maximum = 6.5

Minimum = 0.7

Avg/Min Ratio = 4.89

Max/Min Ratio = 9.29

PRELIMINARY
NOT FOR CONSTRUCTION

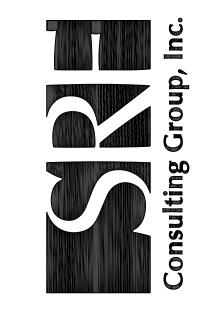

FITCHBURG #1

ORCHARD POINTE

HY-VEE, INC.
5820 WESTOWN PARKWAY
WEST DES MOINES, IOWA 5026
WEST DES MOINES, IOWA 5026
FAX: (515) 267-2935

TRUE NORTH PLAN NORTH

LIGHTING PLAN

DRAWN: DATE:


RAB 2011


SCALE: JOB NUMBER:


1"=40' 7555

HEET:

C6.0

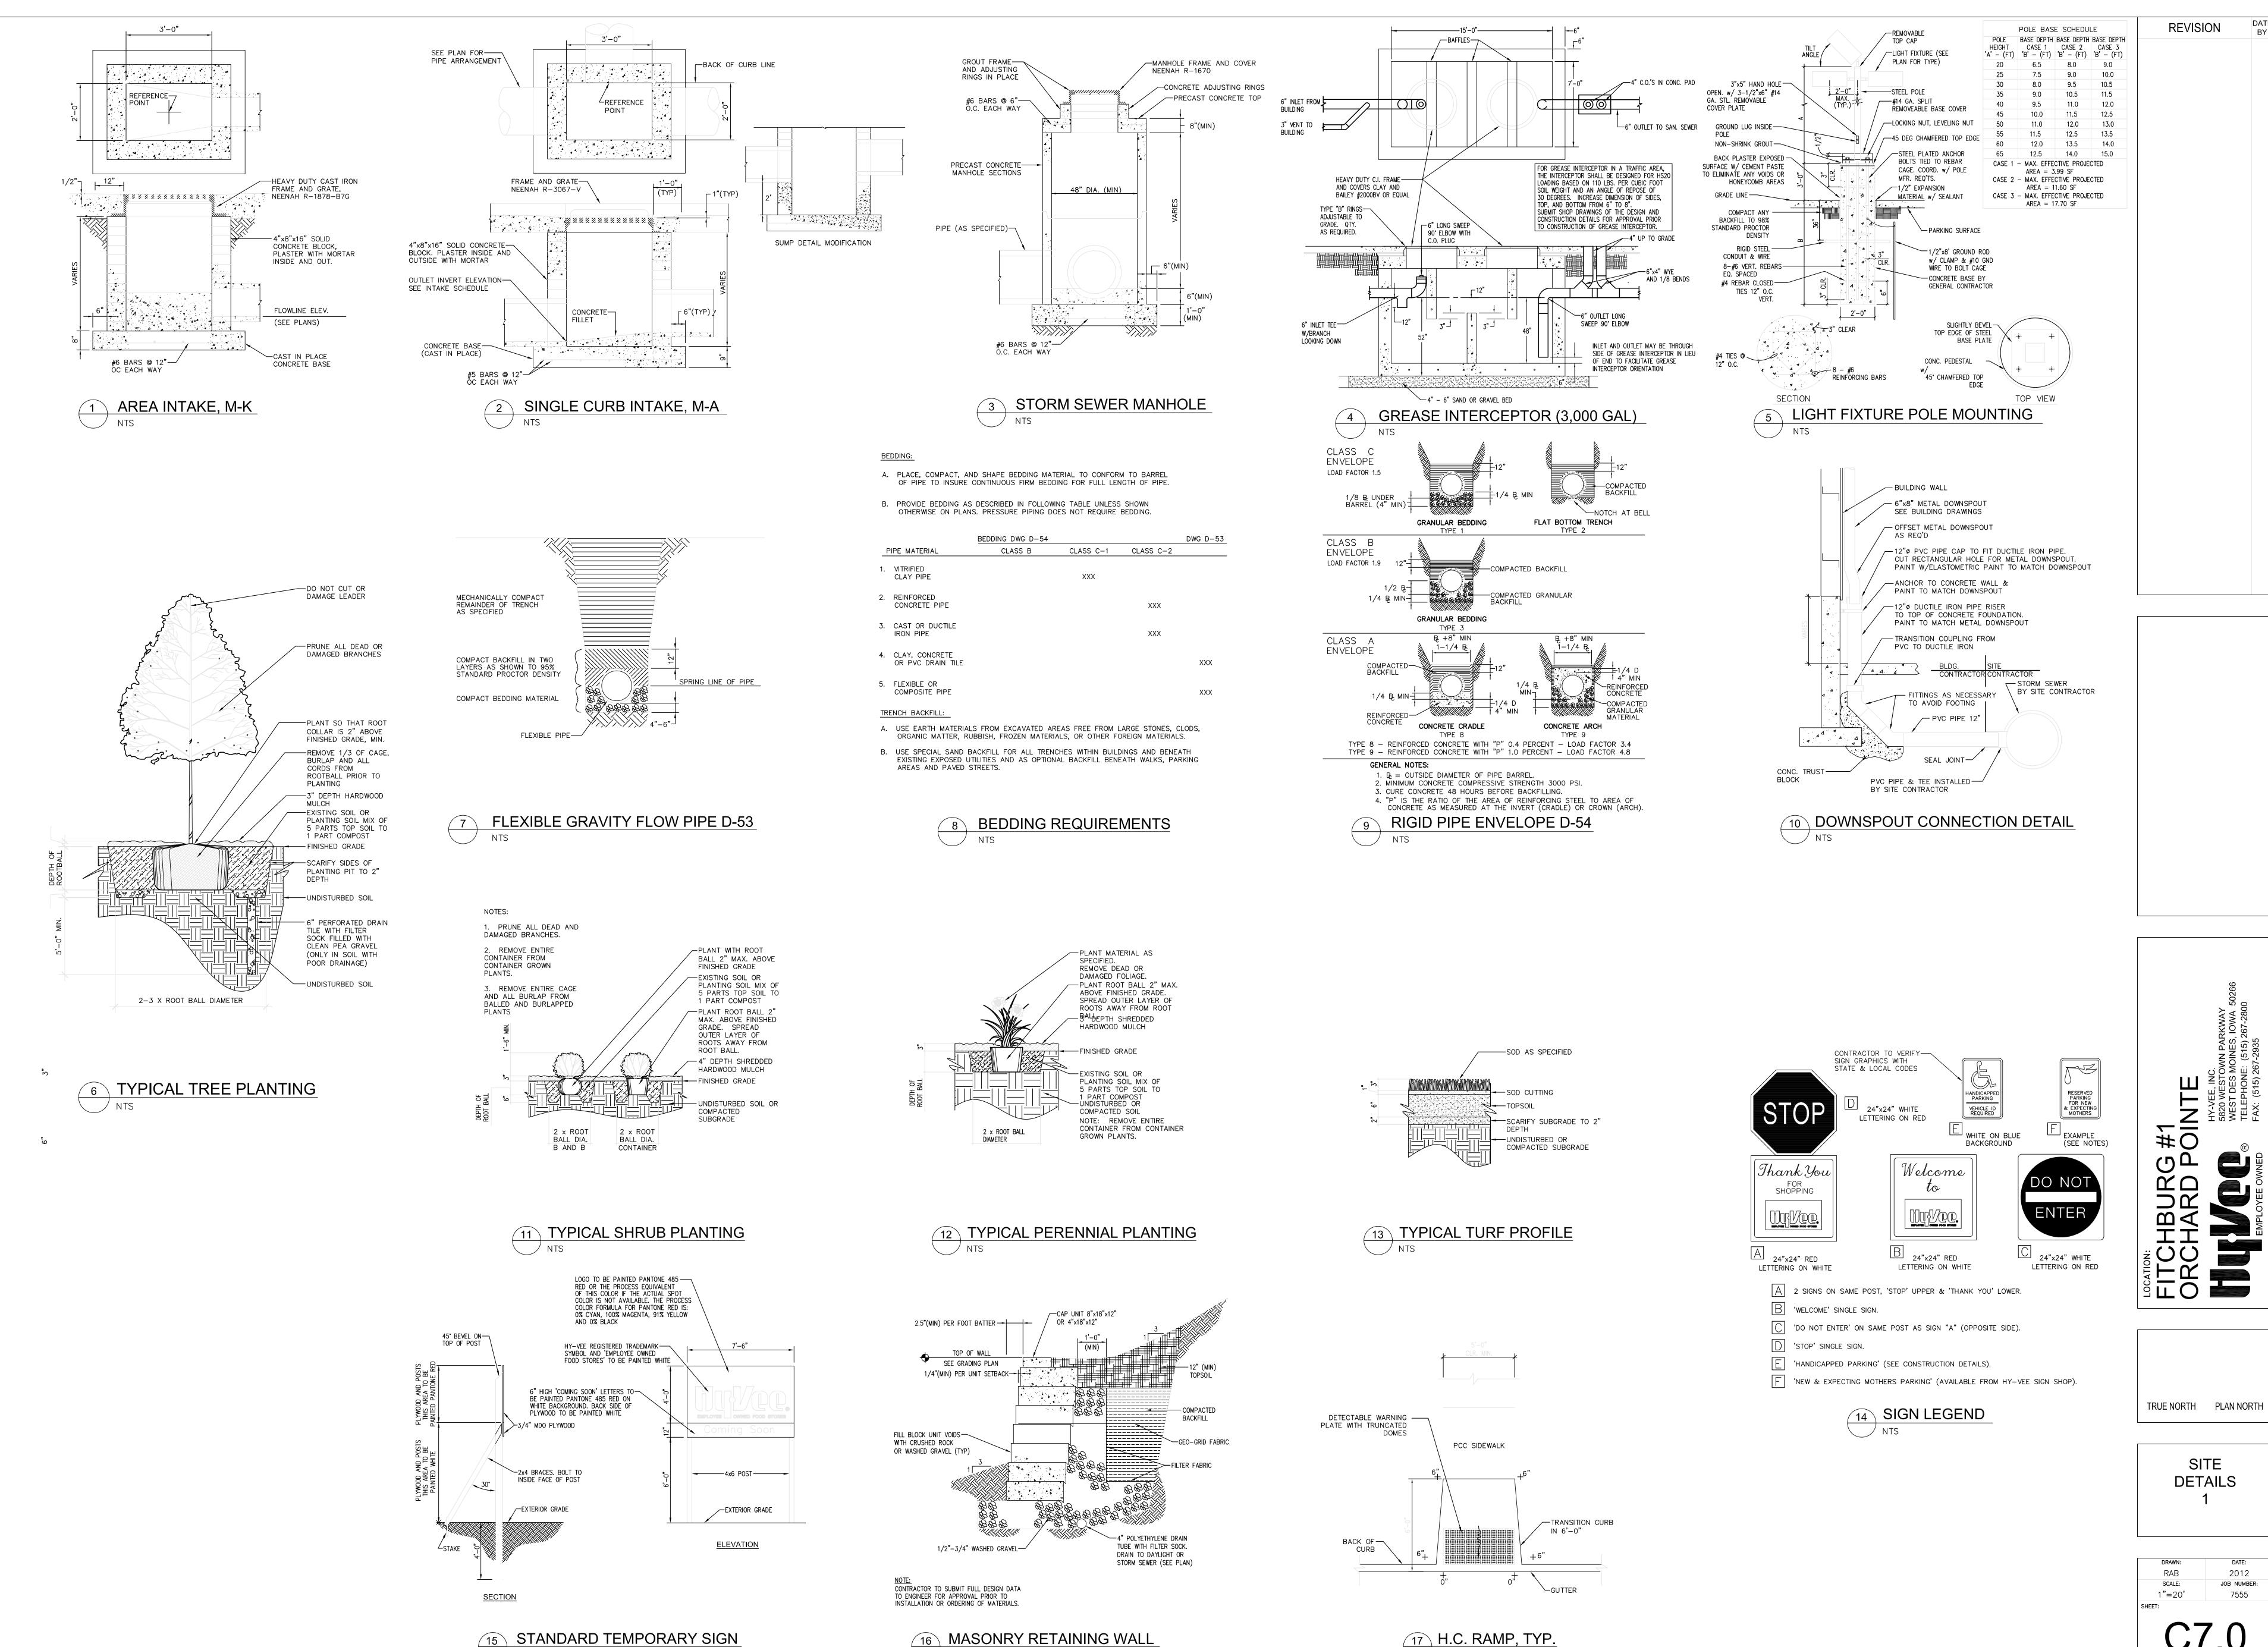

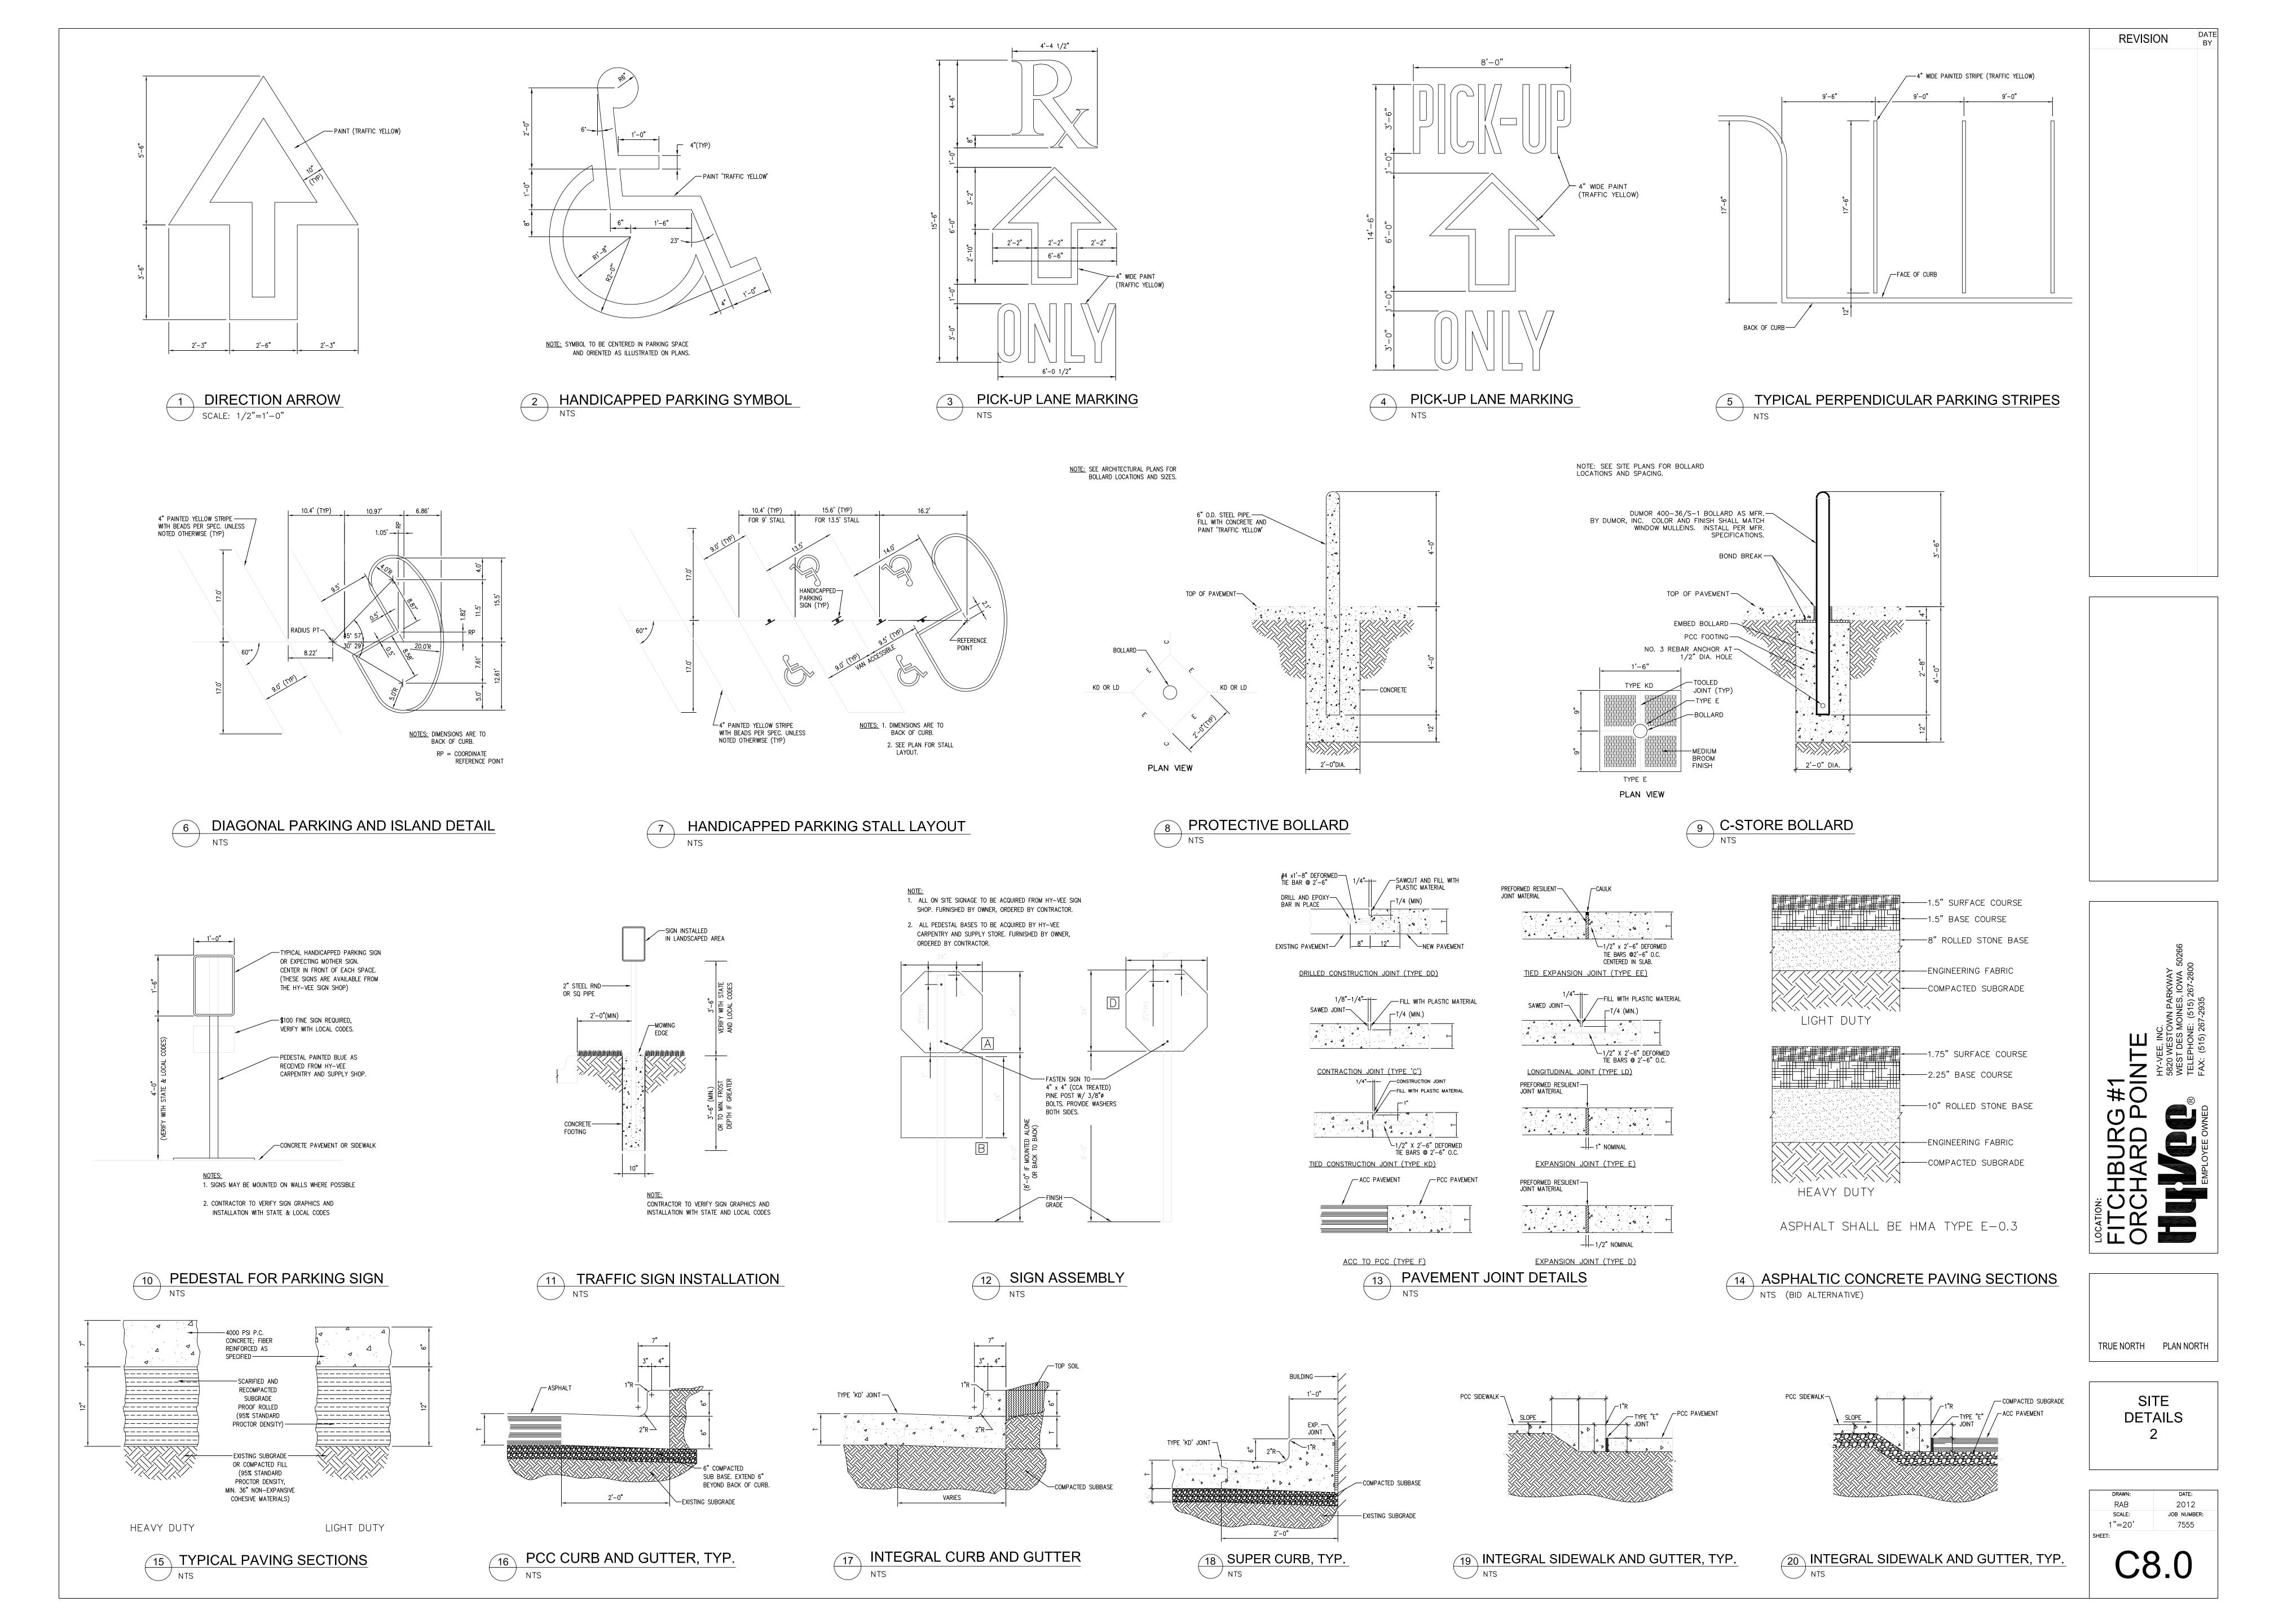


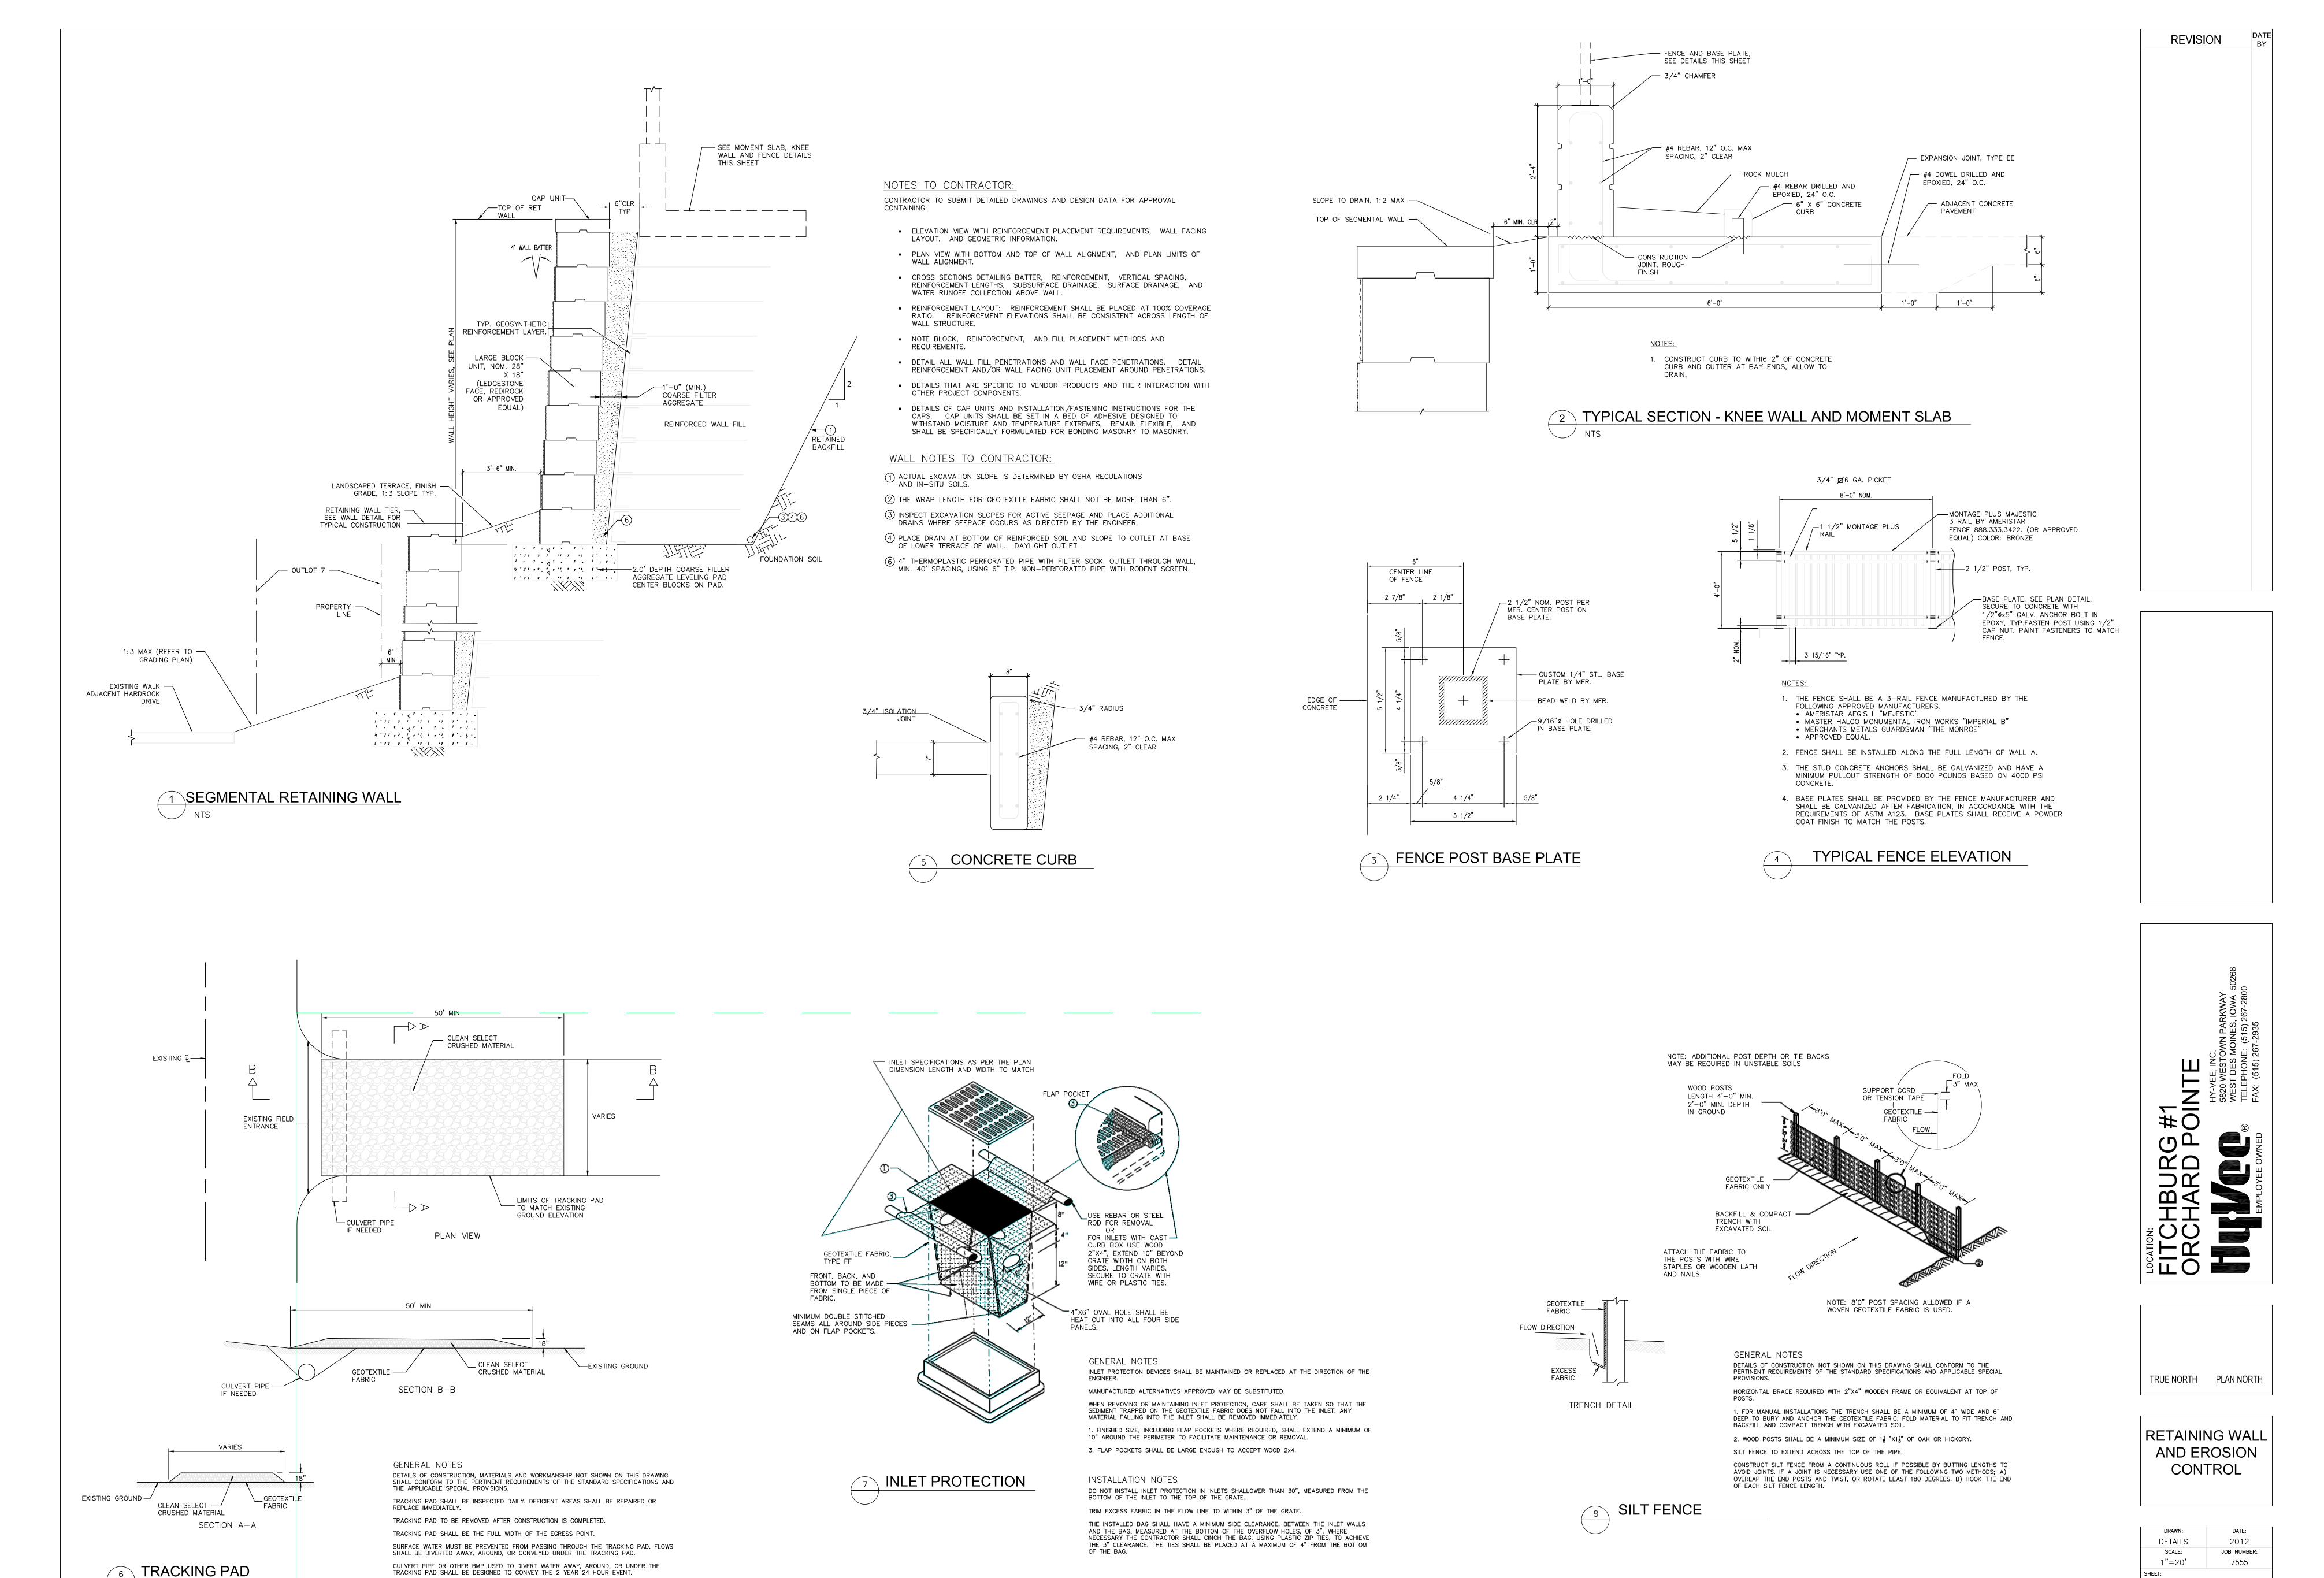

THE COST OF ADDITIONAL BMP TO DIVERT WATER ARE INCIDENTAL TO THE TRACKING PAD BID ITEM.

**Concrete Pipe Division** 



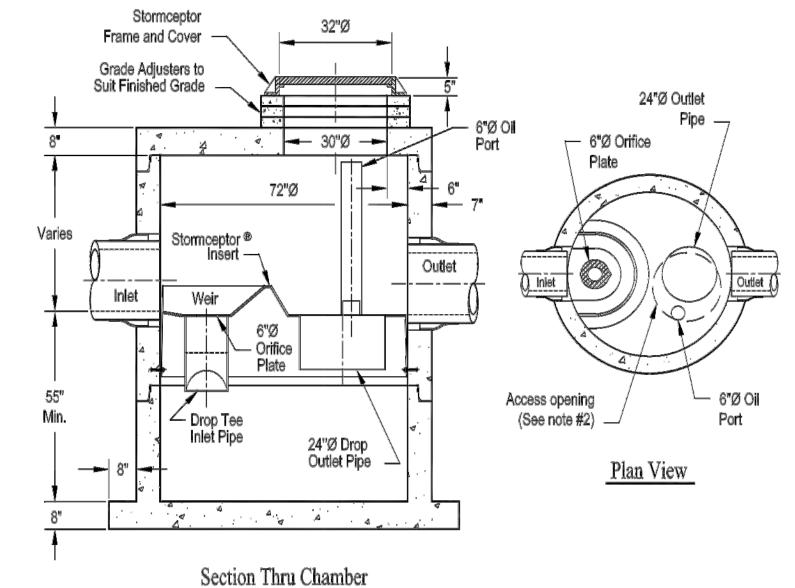

1. The Use Of Flexible Connection is Recommended at The Inlet and Outlet Where Applicable. 2. The Cover Should be Positioned Over The Outlet Drop Pipe and The Oil Port.

The Stormceptor System is protected by one or more of the following U.S. Patents: #4985148, #5498331, #5725760, #5753115, #5849181, #6068765, #6371690.

4. Contact a Concrete Pipe Division representative for further details not listed on this drawing.

STC 2400 Precast Concrete Stormceptor®

(2400 U.S. Gallon Capacity)

Access opening

(See note #2)

Plan View

Rinker 028

24°Ø Outlet

Rinker 031

4 STORMCEPTOR STC 900

Frame and Cover -

Grade Adjusters to

Stormceptor ®

∠ Drop Tee Inlet Pipe

72''Ø

24"Ø Drop Outlet Pipe

96"Ø

Section Thru Chamber


LID & FRAME DESIGNED BY-FRAME & GRATE ENGINEER FOR MIN. AS SPECIFIED BY OTHERS, ANTICIPATED LOADS - LID & FRAME MUST BE SUPPORTED BUT NOT LESS THAN 12" (300MM) LID & FRAME MUST BE SUPPORTED -BY CONCRETE PRECAST RING OR COLLAR BY CONCRETE PRECAST RING OR COLLAR FIELD ADJUST RISER HEIGHT ----FRAME & GRATE FINISH GRADE -CONCRETE PRECAST RING (BY CONCRETE PRECAST RING BY OTHERS OTHERS) REINFORCING AS (BY OTHERS), REINFORCING AS SPECIFIED BY DESIGN LID & FRAME DESIGNED BY - SPECIFIÉD BY DESIGN ENGINEER ENGINEER FOR ANTICIPATED ---- FINAL BACKFILL STRUCTURAL BACKFILL MIN. AS SPECIFIED MINIMUM PER ASTM D2321 8"-24" Ø HDPE PIPE 12" MINIMUM BUT NOT LESS 30"-60" Ø HDPE PIPE ₽ 18" MINIMUM MINIMUM MAXIMUM HDPE RISER -- 36"-60" HDPE PIPE DIAMETER CONCRETE - CLASS I OR II BACKFILL, PER ASTM 2321, COMPACTED IN 8" (200mm) MAX. LIFTS TO A MIN. OF 90% STANDARD PROCTOR SPECIFY DIAMETER & LOCATION BEDDING PER PROJECT SPECIFICATION 4 4 4 . . . UNDISTURBED NATIVE SOIL OR ——/
MATERIAL PER PROJECT SPECIFICATION NOTE: ALL DIMENSIONS ARE  $\pm$  1/2 FOOT.

2 RISER TEE 36-60 PIPE

[1050 MM](1219 MM)| (610 MM) | (1826 MM) | (457 MM) | (292 MM) | (610 MM)|

OUTLET — REDUCER ASTM F 2306 COMPONENT EXCAVATION TRENCH NOTES: NOTE: ALL DIMENSIONS ARE  $\pm$  1/2 FOOT. 1. FOR INSTALLATION RECOMMENDATIONS, SEE STD-702 "TYPICAL RET/DET CROSS-SECTION DETAIL" AND STD-703 "TYPICAL RET/DET/CLEANOUT

3 TYPICAL SUBSURFACE SYSTEM LAYOUT DETAILS

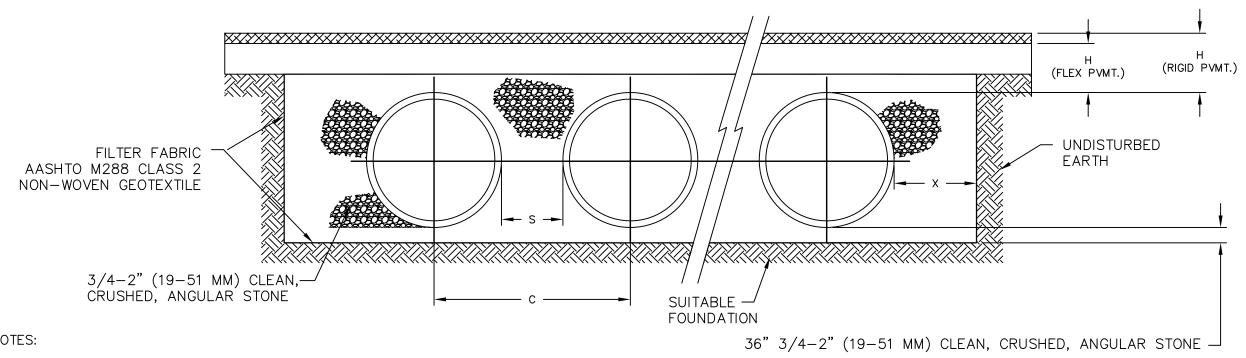

1. ALL REFERENCES TO CLASS I OR II MATERIAL ARE PER ASTM D2321 "STANDARD PRACTICE FOR UNDERGROUND INSTALLATION OF THERMOPLASTIC PIPE FOR SEWERS AND OTHER GRAVITY FLOW APPLICATIONS", LATEST EDITION.

CATCH BASIN

2. ALL RETENTION AND DETENTION SYSTEMS SHALL BE INSTALLED IN ACCORDANCE WITH ASTM D2321, LATEST EDITION AND THE MANUFACTURER'S PUBLISHED INSTALLATION GUIDELINES.

3. MEASURES SHOULD BE TAKEN TO PREVENT THE MIGRATION OF NATIVE FINES INTO THE BACKFILL MATERIAL, WHEN REQUIRED. SEE ASTM D2321.

4. <u>FILTER FABRIC:</u> A GEOTEXTILE FABRIC SHALL BE USED AS SPECIFIED BY THE ENGINEER TO PREVENT THE MIGRATION OF FINES FROM THE NATIVE SOIL INTO THE SELECT BACKFILL MATERIAL.


FOUNDATION: WHERE THE TRENCH BOTTOM IS UNSTABLE, THE CONTRACTOR SHALL EXCAVATE TO A DEPTH REQUIRED BY THE ENGINEER AND REPLACE WITH SUITABLE MATERIAL AS SPECIFIED BY THE ENGINEER. AS AN ALTERNATIVE AND AT THE DISCRETION OF THE DESIGN ENGINEER, THE TRENCH BOTTOM MAY BE STABILIZED USING A GEOTEXTILE MATERIAL.


6. <u>BEDDING:</u> SUITABLE MATERIAL SHALL BE 3/4-2" (19-51 MM) CLEAN, CRUSHED, ANGULAR STONE. UNLESS OTHERWISE NOTED BY THE ENGINEER, MINIMUM BEDDING THICKNESS SHALL BE 36".

7. <u>INITIAL BACKFILL:</u> SUITABLE MATERIAL SHALL BE CLASS I OR II IN THE PIPE ZONE EXTENDING NOT LESS THAN 6" ABOVE CROWN OF PIPE. THE CONTRACTOR SHALL PROVIDE DOCUMENTATION FOR MATERIAL SPECIFICATION TO ENGINEER. MATERIAL SHALL BE INSTALLED AS REQUIRED IN ASTM D2321, LATEST EDITION.

8. <u>MINIMUM COVER:</u> MINIMUM COVER OVER ALL RETENTION/DETENTION SYSTEMS IN NON-TRAFFIC APPLICATIONS (GRASS OR LANDSCAPE AREAS) IS 12" FROM TOP OF PIPE TO GROUND SURFACE. ADDITIONAL COVER MAY BE REQUIRED TO PREVENT FLOATATION. FOR TRAFFIC APPLICATIONS, MINIMUM COVER IS 12" UP TO 36" DIAMETER PIPE AND 24" OF COVER FOR 42" - 60" DIAMETER PIPE, MEASURED FROM TOP OF PIPE TO BOTTOM OF FLEXIBLE PAVEMENT OR TO TOP OF RIGID PAVEMENT.

5 TYPICAL RETENTION/DETENTION CROSS SECTION DETAIL

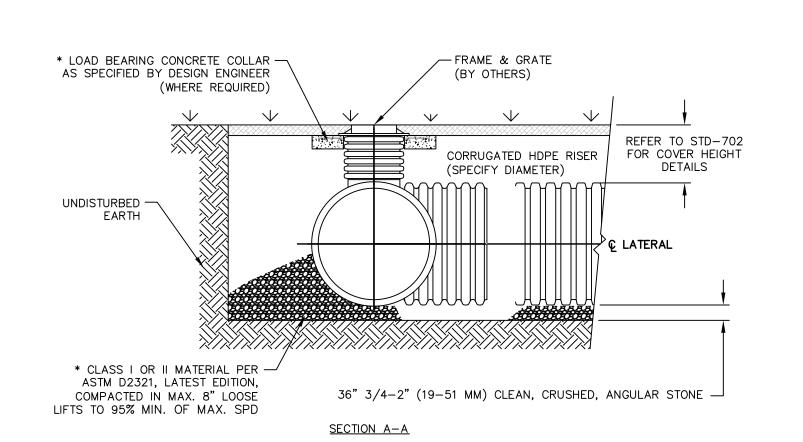

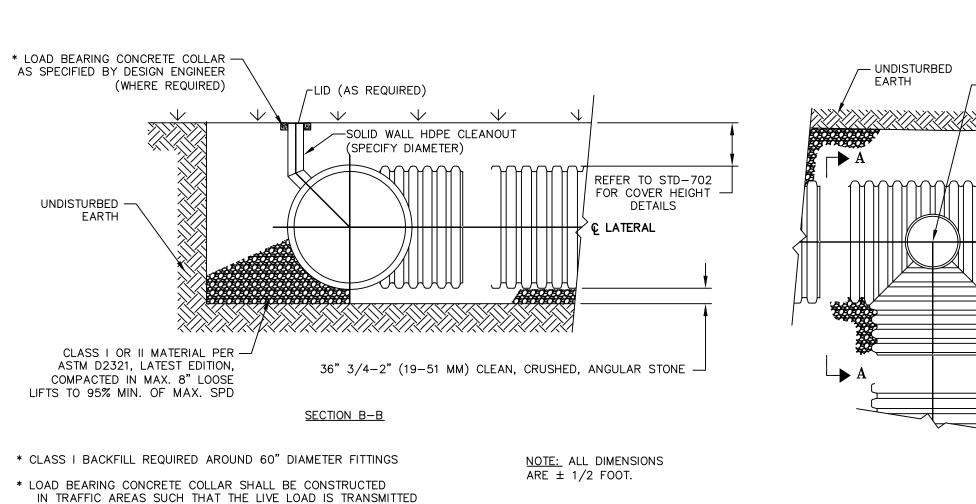

2.5' TO 8'

\_ MAXIMUM

MINIMUM

Notes:

\* CLASS | OR || MATERIAL PER ASTM D2321, LATEST EDITION,


COMPACTED IN MAX. 8" LOOSE

LIFTS TO 95% MIN. OF MAX. SPD

1. The Use Of Flexible Connection is Recommended at The Inlet and Outlet Where Applicable. 2. The Cover Should be Positioned Over The Outlet Drop Pipe and The Oil Port.

3. The Stormceptor System is protected by one or more of the following U.S. Patents: #4985148, #5498331, #5725760, #5753115, #5849181, #6068765, #6371690.

STORMCEPTOR STC 2400

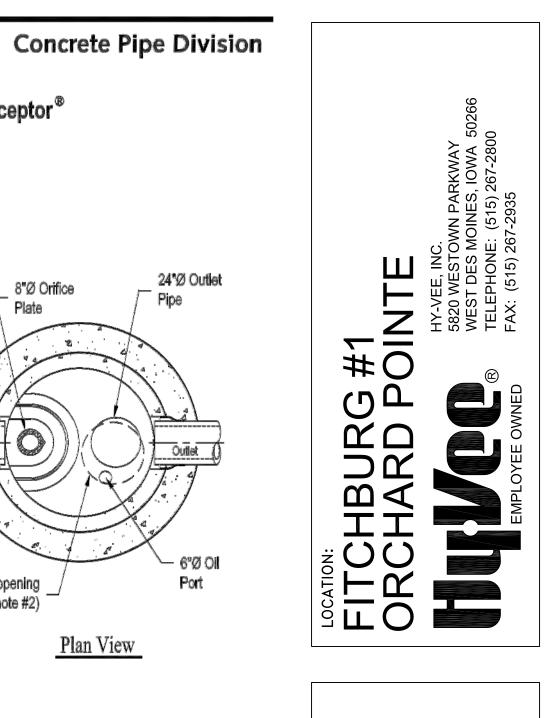


STORMWATER **MANAGEMENT** 

TRUE NORTH PLAN NORTH

RAB 2012 SCALE: JOB NUMBER: NTS

4. Contact a Concrete Pipe Division representative for further details not listed on this drawing. TO THE SURROUNDING SOIL AND NOT DIRECTLY TO THE RISER. RISER AND CLEANOUT

NOMINAL NOMINAL TYPICAL TYPICAL SIDE DIAMETER O.D. SPACING "S"SPACING "C" WALL "X" (NON-TRAFFIC) (TRAFFIC)

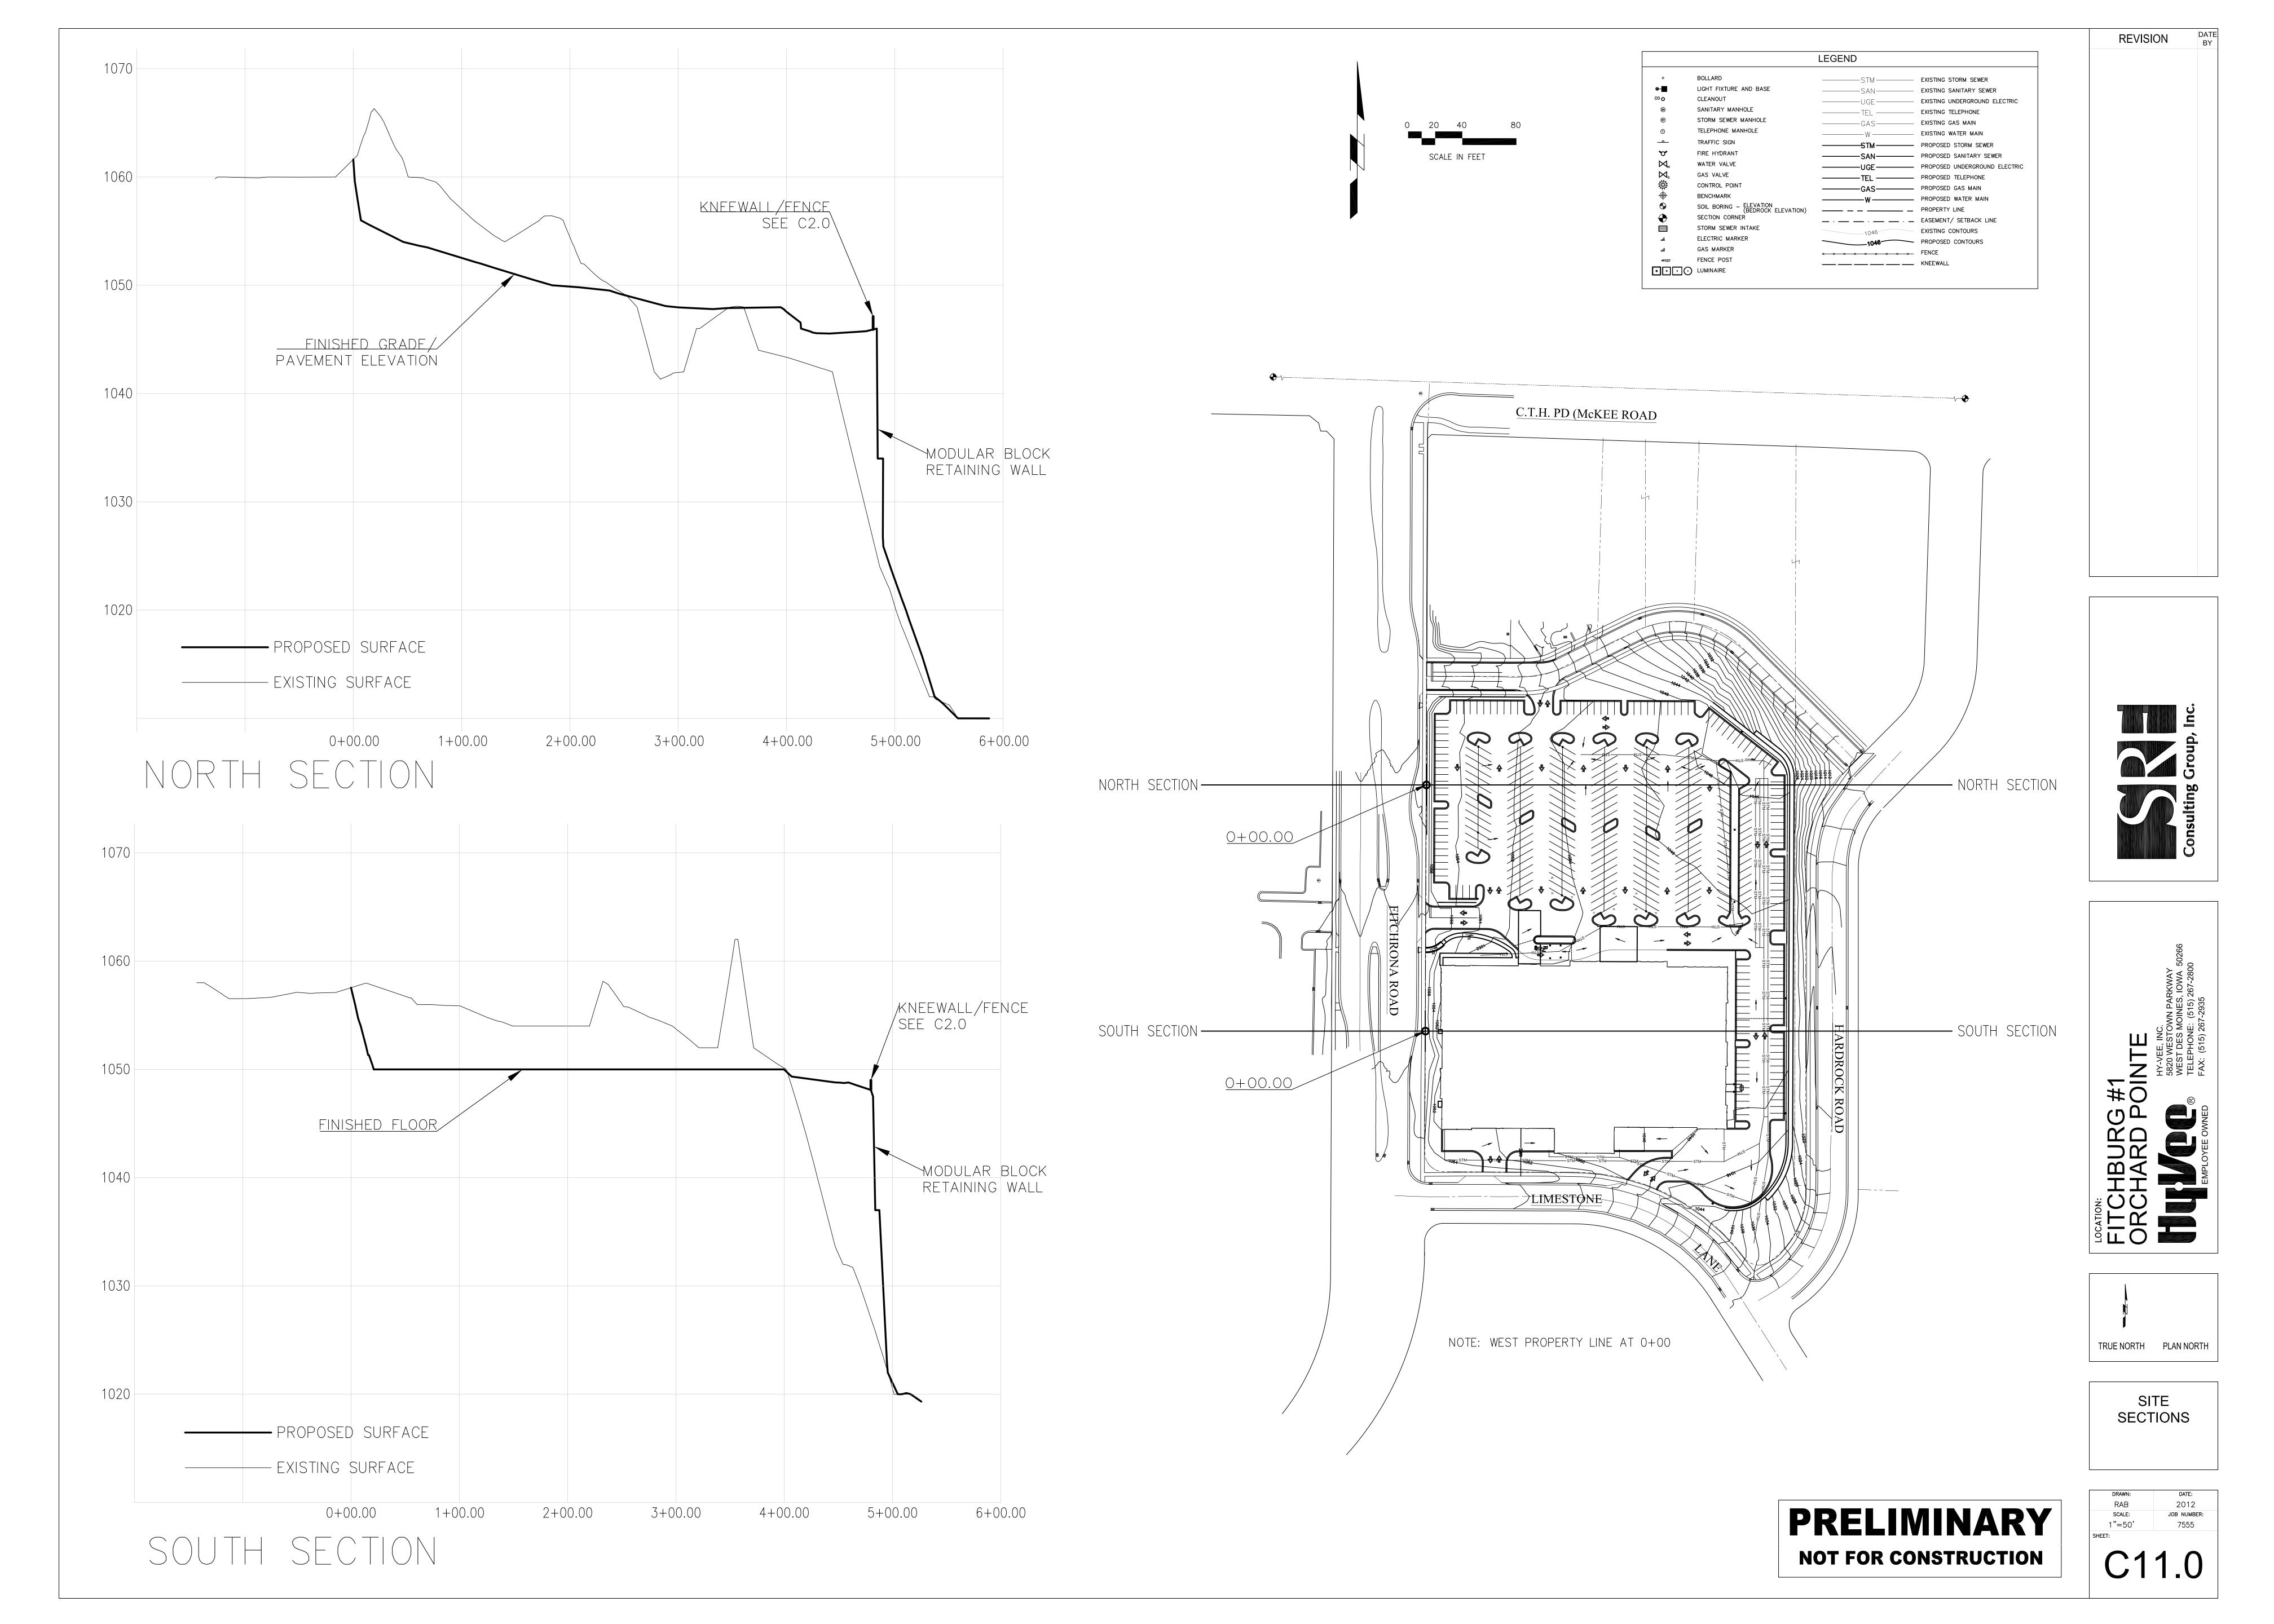



### **MEMORANDUM**

CITY OF FITCHBURG PLANNING DEPARTMENT 5520 LACY ROAD

FITCHBURG, WI 53711 (608) 270-4200

FAX: (608) 270-4275 EMAIL: planning@city.fitchburg.wi.us

TO: Plan Commission

FROM: Tom Hovel, Zoning Administrator/City Planner

Susan Sloper, Community Planner

DATE: February 16, 2012

SUBJECT: February 21, 2012 Plan Commission Items

4. Public Hearing and Consideration of Conditional Use Permit request CU-1913-12 by Ken Dickson of Johnson Bank for a retail grocery store at property associated with 2920 Fitchrona Road, Lot 5 Orchard Pointe.

### **AND**

5. Architectural Design Review request by John Brehm of Hy-Vee Inc for 84,425 sq ft building and site improvements at property associated with 2920 Fitchrona Road, Lot 5 Orchard Pointe.

### Site Details:

Acres: ~8.1

Existing Use: Vacant Current Zoning: B-H

### **Background & Application Description:**

Applicant is requesting a conditional use permit approval to allow for a 24 hour retail grocery store and also Architectural Design Review for a 85,390 sq ft Hy-Vee store at 2920 Fitchrona Road.

### Consistency with Fitchburg Comp Plan:

Future Land Use Plan: BUS (Business)

### Staff Evaluation:

The proposed store will face north with parking predominantly in front of the store. The front elevation provides significant glass, for a "big box". A large retaining wall exists on the east side of the property, and permission from the owner of a strip of land is being obtained to construct the wall. Planning staff, as well as other departments, made a number of comments on the plan set. For planning comments, additional information has been provided or satisfactory comments received.

A few issues exist of which the Plan Commission should be cognizant. First, the resolution approving the amendment to the Comprehensive Development Plan required the applicant to submit written, but not recorded, document obtaining open space credits from outlot 3 or outlot 4 of the Orchard Pointe Plat **prior** to submitting a request for architectural and design approval. This has not been accomplished. At



Hy-Vee's request, however, staff has processed the applications, but has informed Hy-Vee that action on the ADR cannot be taken until the written open space document has been received. Until it is received, the condition of the CDP resolution has not been met. Architectural approval is the last of the steps before solely administrative permitting actions take over.

The applicants also need to obtain a variance for two driveway approaches on two different public streets. One is the main entry drive along Fitchrona Road and the other is the easterly of the two access points to Limestone Lane. Staff is hopeful the Board of Appeals will consider the variance application on Monday, February 20. An access sidewalk to Fitchrona Road is provided to handle pedestrian traffic, but applicants did not wish to provide easier pedestrian access from the private drive. Unfortunately, good pedestrian linkage is not provided to the store through the site from uses north of the private drive. A linear outdoor sales area is noted on the plans next to the front of the building east of the main entry toward the bike parking racks.

According to the site plan, 411 parking auto parking spaces and 24 bicycle parking spaces are provided. 284 auto spaces are required by ordinance, but 342 by the CDP (the CDP set a level of 4.0 stalls per 1,000 sq ft). Because cart corrals have not been identified (they are located by the store manager) there will likely be a decline in number of parking stalls. They are well above the minimum required by the CDP, and no problem should be posed. The bicycle and pedestrian plan asks for 1 bike stall for every 10 auto parking stalls—so 40 bike parking spaces is requested for the project by that plan. They are 16 bike parking stalls short of that required by the Bike/Pedestrian Plan.

Mechanical units are located on the rooftop and screening is provided. Refuse material is handled at rear of the building toward Fitchrona in the west loading docks. Staff questioned the suitability of screening of this area, but the applicant feels it will be sufficient. Photos of equipment show a bright color, and staff would prefer the color be neutral or to match the part of the building they adjoin. A note has been placed on the plans that to have the compactors painted a color that match the building.

A separate liquor license will be required to be issued by the Common Council, and that license will set alcohol sale hours. Hy-Vee has a separate exterior entrance to alcohol sales area which is west of the main grocery entrance. Other than alcohol sales, the main grocery store is proposed to be open 24 hours a day. Staff has not heard objection to the hours from any city department.

### **Staff Recommendation:**

Motion #1: Conditional Use Permit

- 1. No other permit or approval is waived or deemed satisfied except for the conditional use permit approval herein provided.
- 2. Variance for the Fitchrona Road and east Limestone Lane access shall be obtained from the Board of Appeals.
- 3. Location of cart corrals shall not take parking stalls below the 342 stalls required by the CDP.
- 4. If not obtained, applicant shall obtain the required open space credits from outlot 3 or 4 Orchard Pointe.
- 5. Applicant shall pay the cost of installation, operation and maintenance of the traffic signal required at Fitchrona Road—Hy-Vee driveway intersection.

### Motion #2: Architectural Design Review

If the open space credit agreement has been provided, the Plan Commission may consider acting on this request and staff recommends the following conditions.

1. No other permit or approval is waived or deemed satisfied except for the conditional use permit approval herein provided.

- 2. Variance for the Fitchrona Road and east Limestone Lane access is obtained from the Board of Appeals.
- 3. Review and acceptance of the open space credit agreement by the City Attorney, and recording of such agreement.
- 4. Location of cart corrals shall not take parking stalls below the 342 stalls required by the CDP.

### Attachments:

- CU-1913-12 and ADR applications
- 6. Public Hearing and Consideration of rezoning request RZ-1911-11 by Don Bussan to amend the Planned Development District Specific Implementation Plan (PDD-SIP) zoning to allow for an additional volleyball court, expanded decking and site improvements at property associated with 6285 Nesbitt Road, Lot 3 CSM 9636.

AND

7. Architectural Design Review request by Don Bussan for an additional volleyball court, expanded decking, and site improvements at property associated with 6285 Nesbitt Road, Lot 3 CSM 9636.

### Site Details: Acres: ~3.5

Existing Use: Bowling alley Current Zoning: PDD-SIP

### Background & Application Description:

Applicant is requesting approval to add a volleyball court, expand decking and other site improvements including a fence and retaining wall at property associated with 6285 Nesbitt Road, the location of Ten Pin Bowling Alley.

### Consistency with Fitchburg Comp Plan:

Future Land Use Plan: BUS (Business)

Application is consistent with the Comprehensive Plan.

### Staff Evaluation:

Public Works reviewed the application and required a street tree waiver. The trees shown on the original plans for the project showed street trees along Nesbitt Road that were never planted. The applicant has already filed this waiver and provided to public works.

Fire Department commented that there are no issues with the proposed deck; however, if it is enclosed or a roof is added and the deck is attached to the building, the fire sprinkler system will need to be extended to cover the deck area.

The Police Department requests that any existing controls regarding alcoholic beverages on the deck and volleyball courts be maintained. The ADR and rezone approvals do not amend the existing liquor license for the property. The existing liquor license regulations continue, unless amended by Public Safety.

Based on the submitted plans, the proposed fence, retaining wall and volleyball court are shown to extend into the 50' DOT setback. The applicant provided a copy of the DOT Agreement for Waiver of Damages